

Kennet Shopping Centre, Newbury

Demolition Desktop Appraisal

Prepared For:
Lochailort Newbury Ltd

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Date: 14/10/2019

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1.0 Introduction

Lochailort Newbury Ltd (LNL) are looking to acquire a 6-acre site in the centre of Newbury town centre for re-development. The site current site comprises of the 'Kennet Centre' a retail and leisure development. The Kennet centre development can be broadly split into 3 main areas; Retail, a multi-storey car park and Vue multi-screen cinema. The site is approximately trapezoidal in shape and is bound on three sides by roads; Cheap St, Bartholomew St and Market St. The site has a number of interfaces with adjoining properties, to the North is a Victorian retail arcade and within the wider trapezoidal footprint is indented by adjoining retail units and pubs.



Figure 1: Kennet Centre Site

LNL are looking to demolish the bulk of the site comprising of retail area and redevelop into a mix of low-medium rise residential units whilst retaining the Cinema and multi-storey car park (highlighted in green in figure 1).

LNL have commissioned Robert Bird Group (RBG) to conduct a pre-demolition study to determine the impacts of demolishing most of the site whilst retaining the cinema and car park.

2.0 Report Scope

The scope of this report is to conduct a high-level desktop assessment of the potential partial demolition of the Kennet Centre. The desktop review will focus on the historic information made available from LNL, information gathered during an earlier site visit and an online review of historical information.

RBG understand that the 'Kennet Centre' has been developed over multiple phases since the 1970's. Understanding the history of the development will greatly assist in the demolition feasibility assessment as it will identify which parts are structurally independent. As such the first section of the report will discuss the Kennet's centres development.

Section 4 will identify the assumed structural systems used within the various development phases, focusing on the form of construction and likely stability systems.

Section 5 will then interrogate the key interfaces between the different phases as well as the interface to adjoining structures. Throughout the report 'Figure 2: Key Interfaces' below will be cross-referenced to identify the specific area's being discussed. Interfaces A1-A8 focus on the early phases of development with adjacent or adjoining structures. Interfaces B1-B2 relate to the retained multi-storey car park and interfaces C1-C2 will focus on the interfaces with the cinema.



Figure 2: Key Interfaces

Section 6 will assess the feasibility of the proposed partial demolition with a focus on structure. The desktop study is inherently high-level and should be used for discussion only and not to be dependent for pricing. Section 6 will identify the feasibility, envisaged impacts on demolition and critical areas where further investigation should be conducted.

3.0 Site History

The 'Kennet Centre' in its current form has been developed over multiple phases since the 1970's. This has been broadly split into 2 parts the earlier phases assumed to be developed in three stages from 1973 to 1983, these phases cover the retail (phase 1 & 2) and Multi-storey car park and remaining retail (phase 3). Phase 4 covers 2009 extension including a multi-screen cinema.

This section should be read in conjunction with the timeline sketches provided within appendix A.

3.1. Early development phases (Phases 1,2&3)

Development of the 'Kennet Centre' started in 1973 with Phase 1, and shortly followed by Phase 2 assumed completed in 1976, Phase 3 was developed about 10 years later in 1983.

Phase 1 extended from market street to the south of the site where the vehicle ramp servicing the retail back of house areas begins, as part of this phase the building formerly the Sainsbury's was constructed to the left-hand side of the ramp. Retail units 1-23 were constructed as part of phase 1. Shortly after Phase 2 incorporating retail units 24-44 was constructed to the North of Phase 2 with a movement joint extending east west across the site. Phase 2 extended north to the Victorian retail arcade on the northern boundary of the site.



Figure 3: Historic Photo of Phase 2 Construction and looking back on Google street view at interfaces A7&A8

Figure 3 of Phase 2 of the development is looking North-North-East the building on top right of the picture is at the junction of Bear Lane and Cheap St. In this photo we can see both the A6 and A5 interfaces illustrated on Figure 2. Clearly from this photo the adjoining properties at interfaced A5 and A6 are structurally independent of the historic Kennet centre development. Additionally, from interrogating interface A8 there is physical separation between the existing structures.



Figure 4: Bartholomew St and North West corner of Site Prior to Early Phase development

Figure 4 is looking north along Bartholomew St in advance of the early phases of development looking at where currently stands the 'The Newbury' public house interface A1 on Fig 2. Figure 5 below of the Phase 3 looking west from the site of the Phase 3 construction looking at Bartholomew St with 'The Newbury' on the left. Both images indicate that 'The Newbury' was a free-standing structure in advance of the Kennet centre development.



The Newbury

Figure 5: Bus Station prior to Phase 3 development

Phase 3 in 1983, developed the western portion of the site adjacent to Bartholomew St, this portion of the site was utilised as a bus garage up till the Phase 3 development as indicated in figure 5.



Figure 6: Phase 3 Construction looking at Bartholomew St



Figure 7: Phase 3 from Bartholomew St 1990's

Figures 6 and 7 show the Phase 3 portion of the Kennet centre under construction and in operation during the 1990's respectively. As part of the Phase 3 development the multi storey car park (to be retained) was constructed, a portion of the car parking provision provided during this phase was constructed on the roof of a retail unit indicated in Black on figure 1.

3.2. Phase 4: Cinema

The latest extension to the Kennet centre (2009) consisted of a multi-screen cinema and 5 restaurant units over 3 storeys. The 6,000m² extension is positioned in the South East corner of the development on a former car park. The Phase 4 development required the relocation of a substation from under the ramp access to the left of the ramp adjacent to the ramp. Figures 8 and 9 below show the pre-phase 4 development and then the new structure intertwined between the ramp and former Sainsbury's unit where the substation now is located.



Figure 8: Phase 1 in advance of interfacing Phase 4 construction



Figure 9: Phase 4 interface with Phase 1; view of ramp and former Sainsbury

4.0 Assumed Structural Systems

RBG's assessment is based upon high level observations and assumptions regarding likely forms of construction to be adopted. A more in-depth intrusive survey would be required to determine the true form of the various structural systems which is beyond the scope of this report.

4.1. Early development phases (Phases 1,2&3)

Phases 1 & 2 of the development appear to have been constructed in very similar forms of construction. Figure 10 is a picture of the Phase 2 construction shows a piling rig in use, this is significant in the fact that the early phases are only 2 storeys and could potentially have been founded on shallow foundations (e.g. PAD footings). Piled foundations mean that the weight from the structure is founded at depth so will have less impact on the adjoining structures in both construction and now in demolition. The adjoining properties at interfaces A1-A8 due to their age

will be founded on shallow foundations, the difference in foundation systems is a positive indication that they are not shared.



Figure 10: Piling Rig construction Early Phases of Kennet Centre

The initial site walk around showed that the initial phases of retail development are of RC frame construction typically on a 6m grid. Figure 11 is a picture taken within Phase 2 in unit which sits in the North-West corner of the site with Bartholomew St shows a RC frame construction with a beam RC grillage. The fire stair access shown at the back of the unit is possibly to be also of RC construction and could be providing lateral stability to this phase of development.



Figure 11: Phase 2 Retail Unit RC frame

The bulk of the early phases were constructed as single storey RC frame with load bearing masonry storage/BOH area's at Level 1 podium level. As can be seen in figure 12 a movement joint splits Phases 1 and 2. Phases 1 and 2 are sheltered from wind by adjacent properties, the low-rise nature and heavy structure (RC) means these phases are not particularly susceptible to lateral instability.

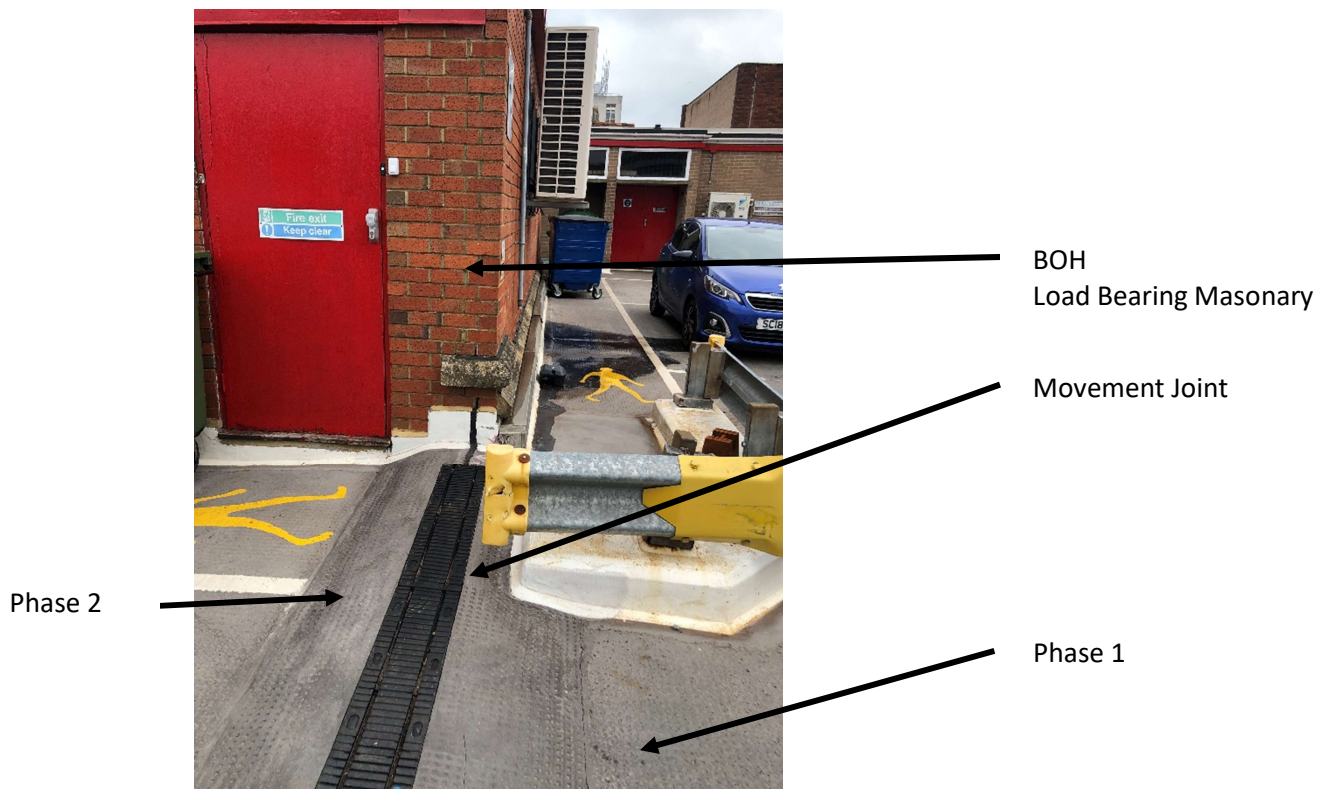


Figure 12: Movement Joint Between Phase 1 and 2 showing BOH area's built on RC podium

The Phase 3 development is split between the additional retail units and the multi-storey car park. There is little drawing information relating to retail portion of Phase 3. However, figure 13 which is a ground floor drainage drawing for phase 2 shows the proposed Phase 3 development (cyan). From this drawing we can see that the grid will follow closely that of Phase 2 and would lead us to assume that the Phase 3 retail was constructed in a similar manner to both phase 1 and 2.

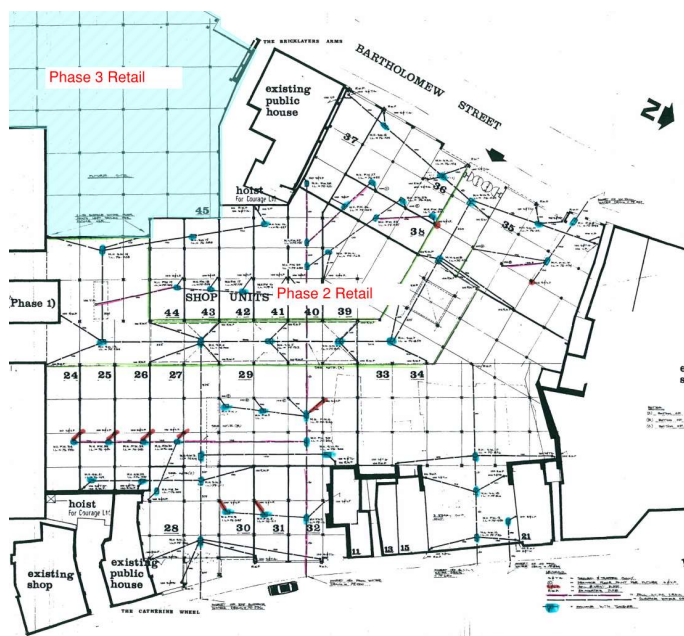


Figure 13: Phase 2 Ground Floor Drainage Plan

Historic drawing information of the multi-storey car park and photo's taken during an earlier site visit indicate that the 3-storey portion of the car park is structurally independent of the 2nd floor roof deck at least in the North-south direction where a movement joint (M.J.) exists as indicated in figure 14 below.

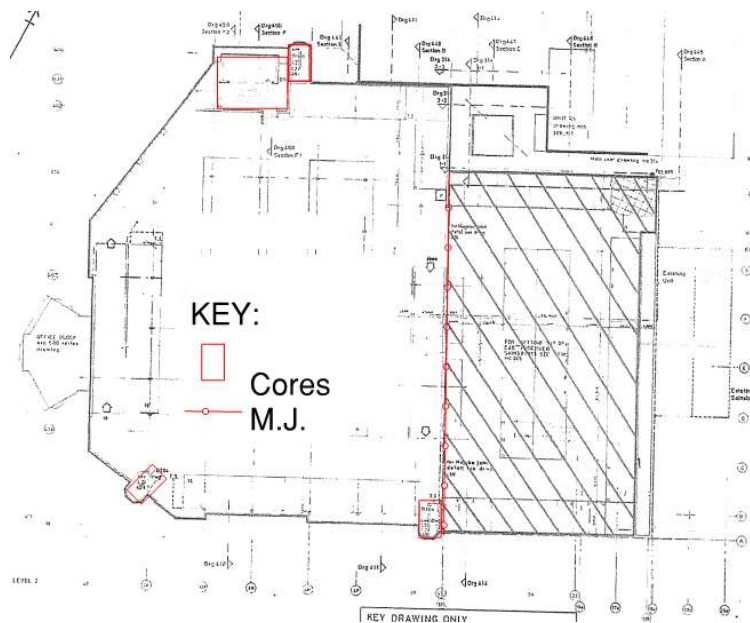


Figure 14: Phase 3 Multi-Storey car park Plan

The 3-storey car park looks to utilise the cores highlighted in red on figure 14 for lateral stability. They are constructed as RC band beams and coffered slabs, presumed to be founded on pile foundations as with the earlier phases.

4.2. Phase 4: Cinema

The 6,000m² extension is of steel framed construction, on piled foundations as indicated on the contractors (Sisk) website. We can reasonably assume the lateral stability is provided in the form of braced bays and/or braced cores, all though at this time these have not been specifically identified.

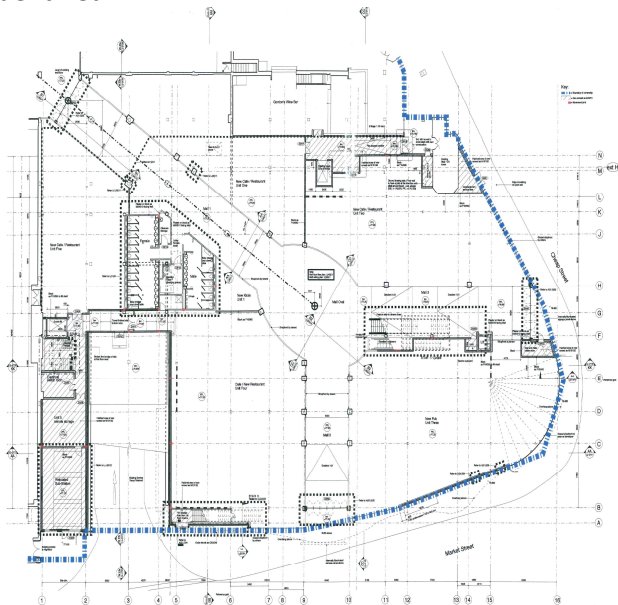


Figure 15: Phase 4 Ground Floor GA

Majority of the phase 4 site was constructed on a former car park positioned to the east of the Phase 1 vehicle ramp (gridline 5). A portion of the phase 1 retail was redeveloped but appears to have retained the ground floor structure including the ramp. The substation formerly beneath the ramp was relocated to the left side of the ramp on the Market St elevation, the remaining infill area between the ramp and former Sainsbury's unit is a 2-storey steel frame structure. It can be reasonably assumed that due to the ramp intersecting the phase 4 development the structure either side of gridline 5 are independent in terms of structural stability.

5.0 Critical Interfaces

Critical interfaces discussed within this section will focus on those identified in figure 2. These have been broadly split into three area's due to their significance in relation to the proposed demolition.

- A: Early phases 1-3 and how they interact with the structures that adjoin them or sit close to the site boundary
- B: Interface of retained multi-storey car park and the phase 3 retail structure to the north and East
- C: Phase 4 Cinema's interfaces with Phase 1

It is beyond the scope of this document to interrogate interfaces with third party assets such as highways or sewers. Service diversions especially those from the substation adjacent to the ramp are likely to be required but do not fall within the scope of this document.

5.1. A: Early Phases to adjoining properties

During the desktop study there was little detailed structural information available relating to the Phase 1 and 2 developments. The A1-A8 interfaces are extensive and are highly variable as they adjoin several different properties presumed to have been constructed over a long period of time dating back many years 100+.

However, a search of historic photo's has proved useful in identifying that many of the structures at the A1-A8 interfaces appear to have been free standing independent structures in advance of the Kennet Centre development. These are clearly visible within Figures 3,4,5&6 and there is further evidence of this gathered in appendix C.

We can also assume that based on a piling rig visible on figures 3 & 10 the Kennet Centre is founded on piled foundations at depth. Based on this assumption it would be reasonable to assume that the foundations at these interfaces are structurally independent. It is also reasonable to assume that the RC frame structure differs greatly from the forms of structure of adjoining properties likely to be traditional load bearing masonry construction. As a result, it is very unlikely that the Kennet centre is dependent on adjoining structures for structural support.

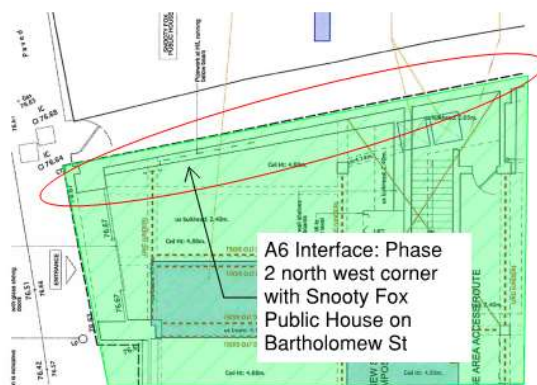


Figure 16: Phase 2 North West Corner

A renovation drawing provided (figure 16) within the LNL information shows the unit within the furthest North West corner (A6) adjacent to 'The globe Inn' public house. This drawing clearly shows as assumed the phase 2 development is structurally independent of the adjoining structure at this interface.

5.2. B: Phase 3 Multi Storey Car Park to Retail

This interface is in many ways the simplest to interpret as we have some record drawing information of the structure in this area. The photograph in figure 17, looking at the movement joint dividing the multi-storey car park with the roof car parking above the supermarket unit presumed to be constructed as an extension to the supermarket visible in figure 8. The detail of which (figure 18) was found within the historic drawing information and correlates to interface B2.

This movement joint corresponds conveniently with the proposed demolition line along that elevation.

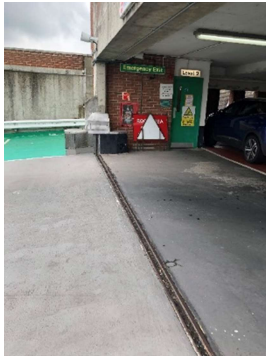


Figure 17: Movement Joint along interface B2

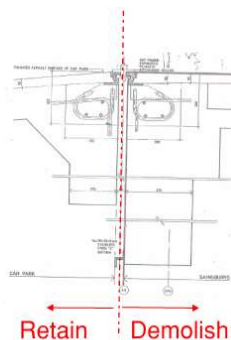


Figure 18: Detail of Movement Joint along interface B2

Unfortunately, the northern interface B1 is not as clearly defined on the record drawing information available nor was this an area inspected during the earlier site visit. We cannot confirm at this stage whether there is a movement joint along this interface to determine whether this interface is structurally independent.

5.3. C: Phase 4 Cinema to Phase 1

The interfaces of phase 4 to Phase 1 are in many ways the most complex. Fortunately, the drawing information available for the phase 4 development is the clearest to understand.

The northern boundary C1 is clearly shows the structures are independent as can be seen in photo of figure 19 there is clear structural separation.



Figure 19: Interface C1

The interface with phase 1 and phase 4 as previously described in section 4.2 as they are intertwined. Fortunately, as indicated in figure 20 the green outline representing the phase 4 first floor structural outline shows a clear split from the cinema to the 'infill area' constructed between the ramp and the former Sainsbury's supermarket unit.

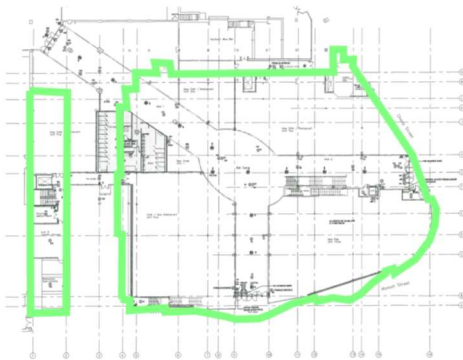


Figure 20: Phase 4 First Floor Outline with Ground Floor

The superstructure of phase 4 is divided by the access ramp which LNL intend to demolish. Looking at this interface C2 at more depth from the record drawings it is clear that the columns supporting the new phase 4 structure within unit V5 are completely independent to the phase 1 ramp.

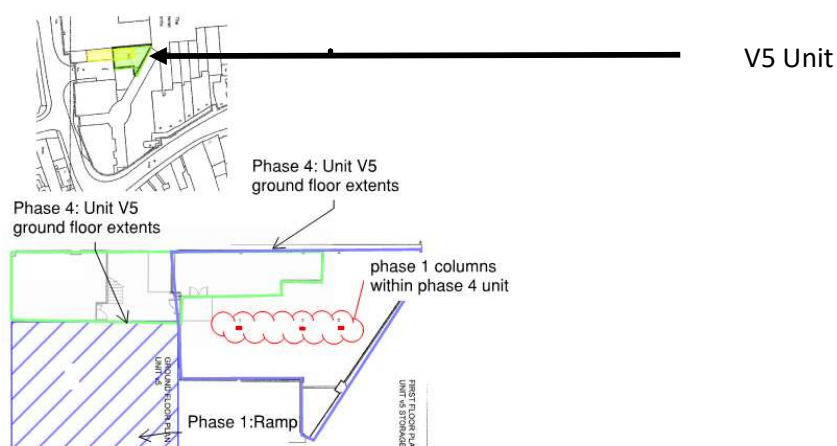


Figure 21: Unit V5 and Phase 1 Ramp

As can be seen in figure 21 the phase 1 and 4 structures are independent. As the ramp splits the phase 4 construction along the proposed demolition line this would infer that the phase 4 structure west of gridline 5 could be demolished without affecting the global stability of the Cinema.

Interrogating the drawing information available for the phase 4 team there appear to be settlement joints and columns of the 2 phases positioned along a common line. This infers there is structural

separation. A high level review of the Phase for GA drawing would indicate a suitable demolition line along the C2 interfaces, highlighted by the green line on Figure 22.

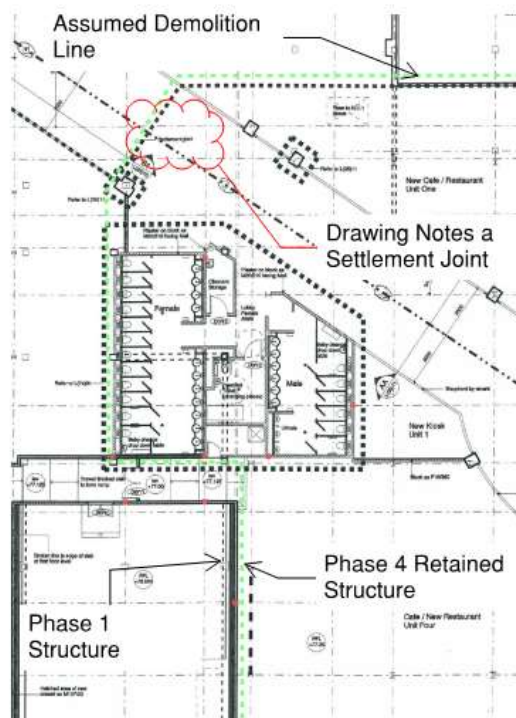


Figure 22: Phase 4 GA with assumed ground floor demolition line

6.0 Demolition Feasibility Assessment

As has been discussed previously the Kennet centre has been developed over multiple phases over decades. The historical structural drawing information available at this time is very limited and so it has been important to understand the history of the phased developments in order to inform our understanding of the interfaces and as such understand the impact demolishing large sections of the Kennet Centre.

Most of the demolition will occur in the northern portion of the site and will impact the A1-A8 interfaces as illustrated on figure 2. From the information available we can reasonably assume that the Kennet Centre Phases 1-3 are structurally independent of the party wall structures to the North of site and those along Bartholomew St and Cheap St. Whilst structurally independent these interfaces in many instances abut one another and the demolition strategy is to be developed cognisant of this especially in relation to noise and vibration effects of adjacent properties during demo. Whilst we are confident that the foundations are independent at these interfaces and likely to be only local to the column positions, care should be taken when grubbing out these to ensure adjacent properties are not undermined. If suited to the new proposed development, it may well be worth leaving the Kennet Centre foundations in place to avoid such effects.

Except for the relocated substation adjacent to the ramp on Market St from the information available to RBG there was no indication that within the site footprint there are any other third-party assets or easements that would require special consideration during demolition.

The B1 and B2 interfaces relating to the multi storey car park vary significantly. The B2 interface running North-South between the retained 3 storey car park and the car deck on top the supermarket unit is clearly separated by a movement joint. This would infer that all the structure along this interface could be safely demolished without affecting the stability of the retained multi-storey car park, but this would need to be confirmed by further inspection.

The B1 interface will require further investigation to understand the interaction with the retained multi-storey car park. As the multi storey car park is 3 storeys and the adjoining structure is only single storey it is highly likely that they are structurally independent.


The C1 and C2 interfaces relating to the retained Cinema buildings are complex in that the Phase 4 development is intertwined with the Phase 1 development. We've identified that fortunately the structure supporting the cinema would appear to be generally structurally independent in terms of global stability. RBG recommend further investigative works should be carried out to determine an optimal demolition line that would optimise the development opportunity whilst retaining a functioning cinema.

Cinemas are inherently susceptible to the effects of noise and vibration; the demolition strategy should be developed in a manner that will retain full functionality of the cinema complex during demolition.

In summary RBG's desk study would conclude that following favourable investigative works relating to the C2 and B1 interfaces a demolition strategy could be developed that would allow the safe demolition of the 'Kennet Centre' without negatively impacting the structural stability of retained structures.

Appendix A

Timeline Sketches

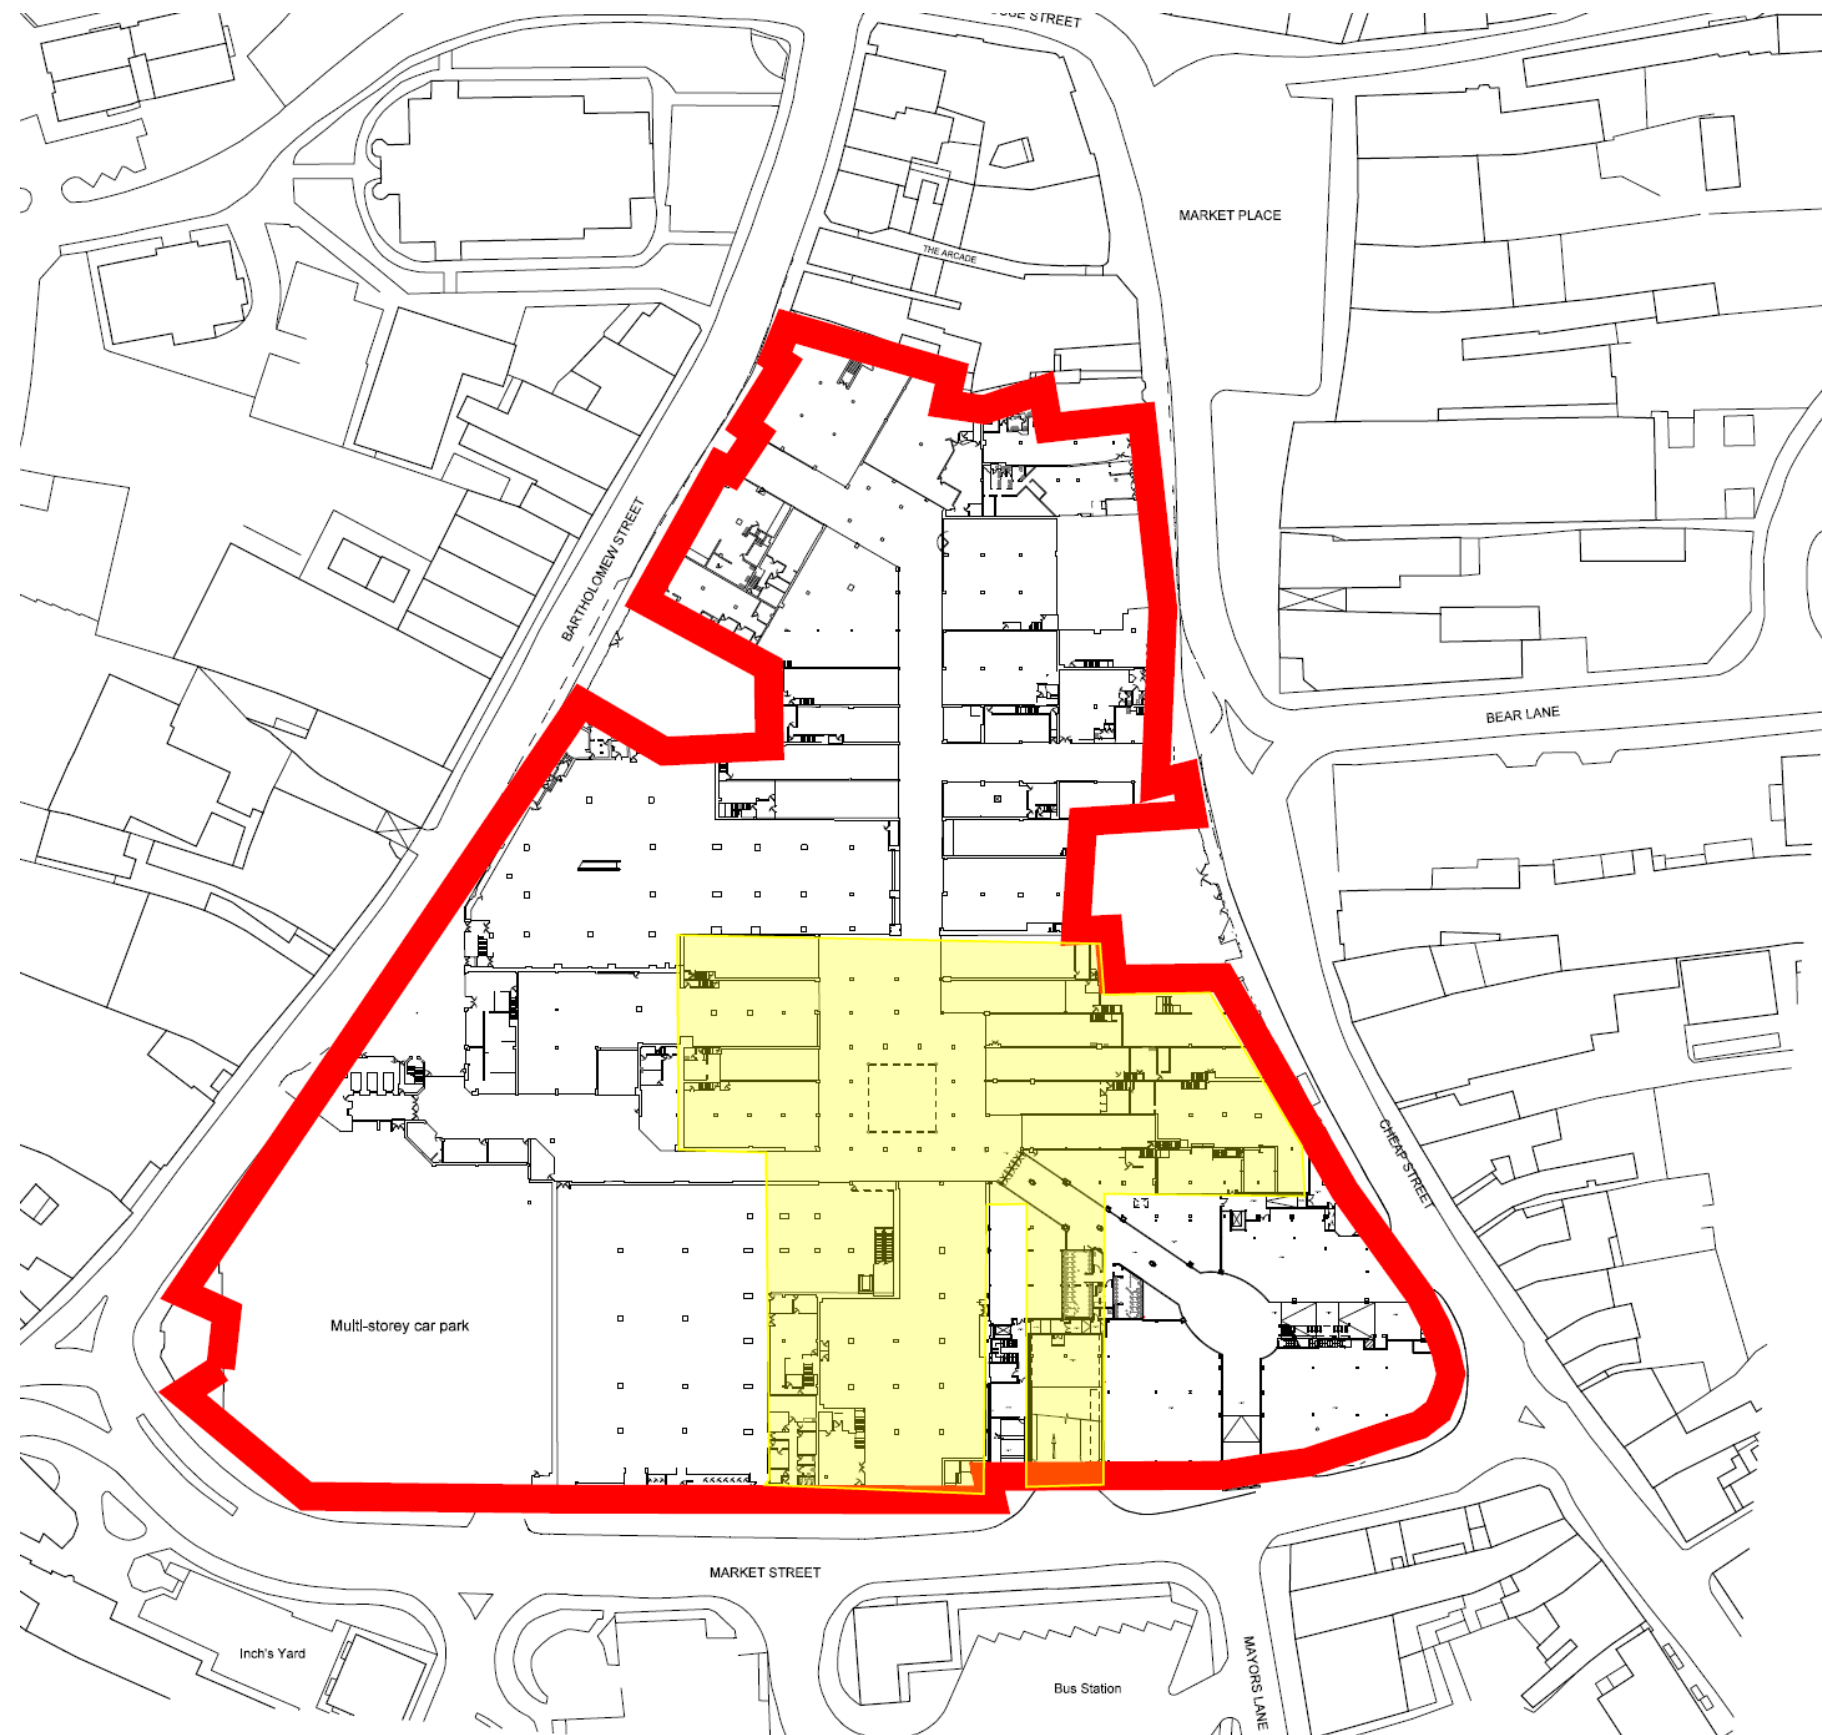

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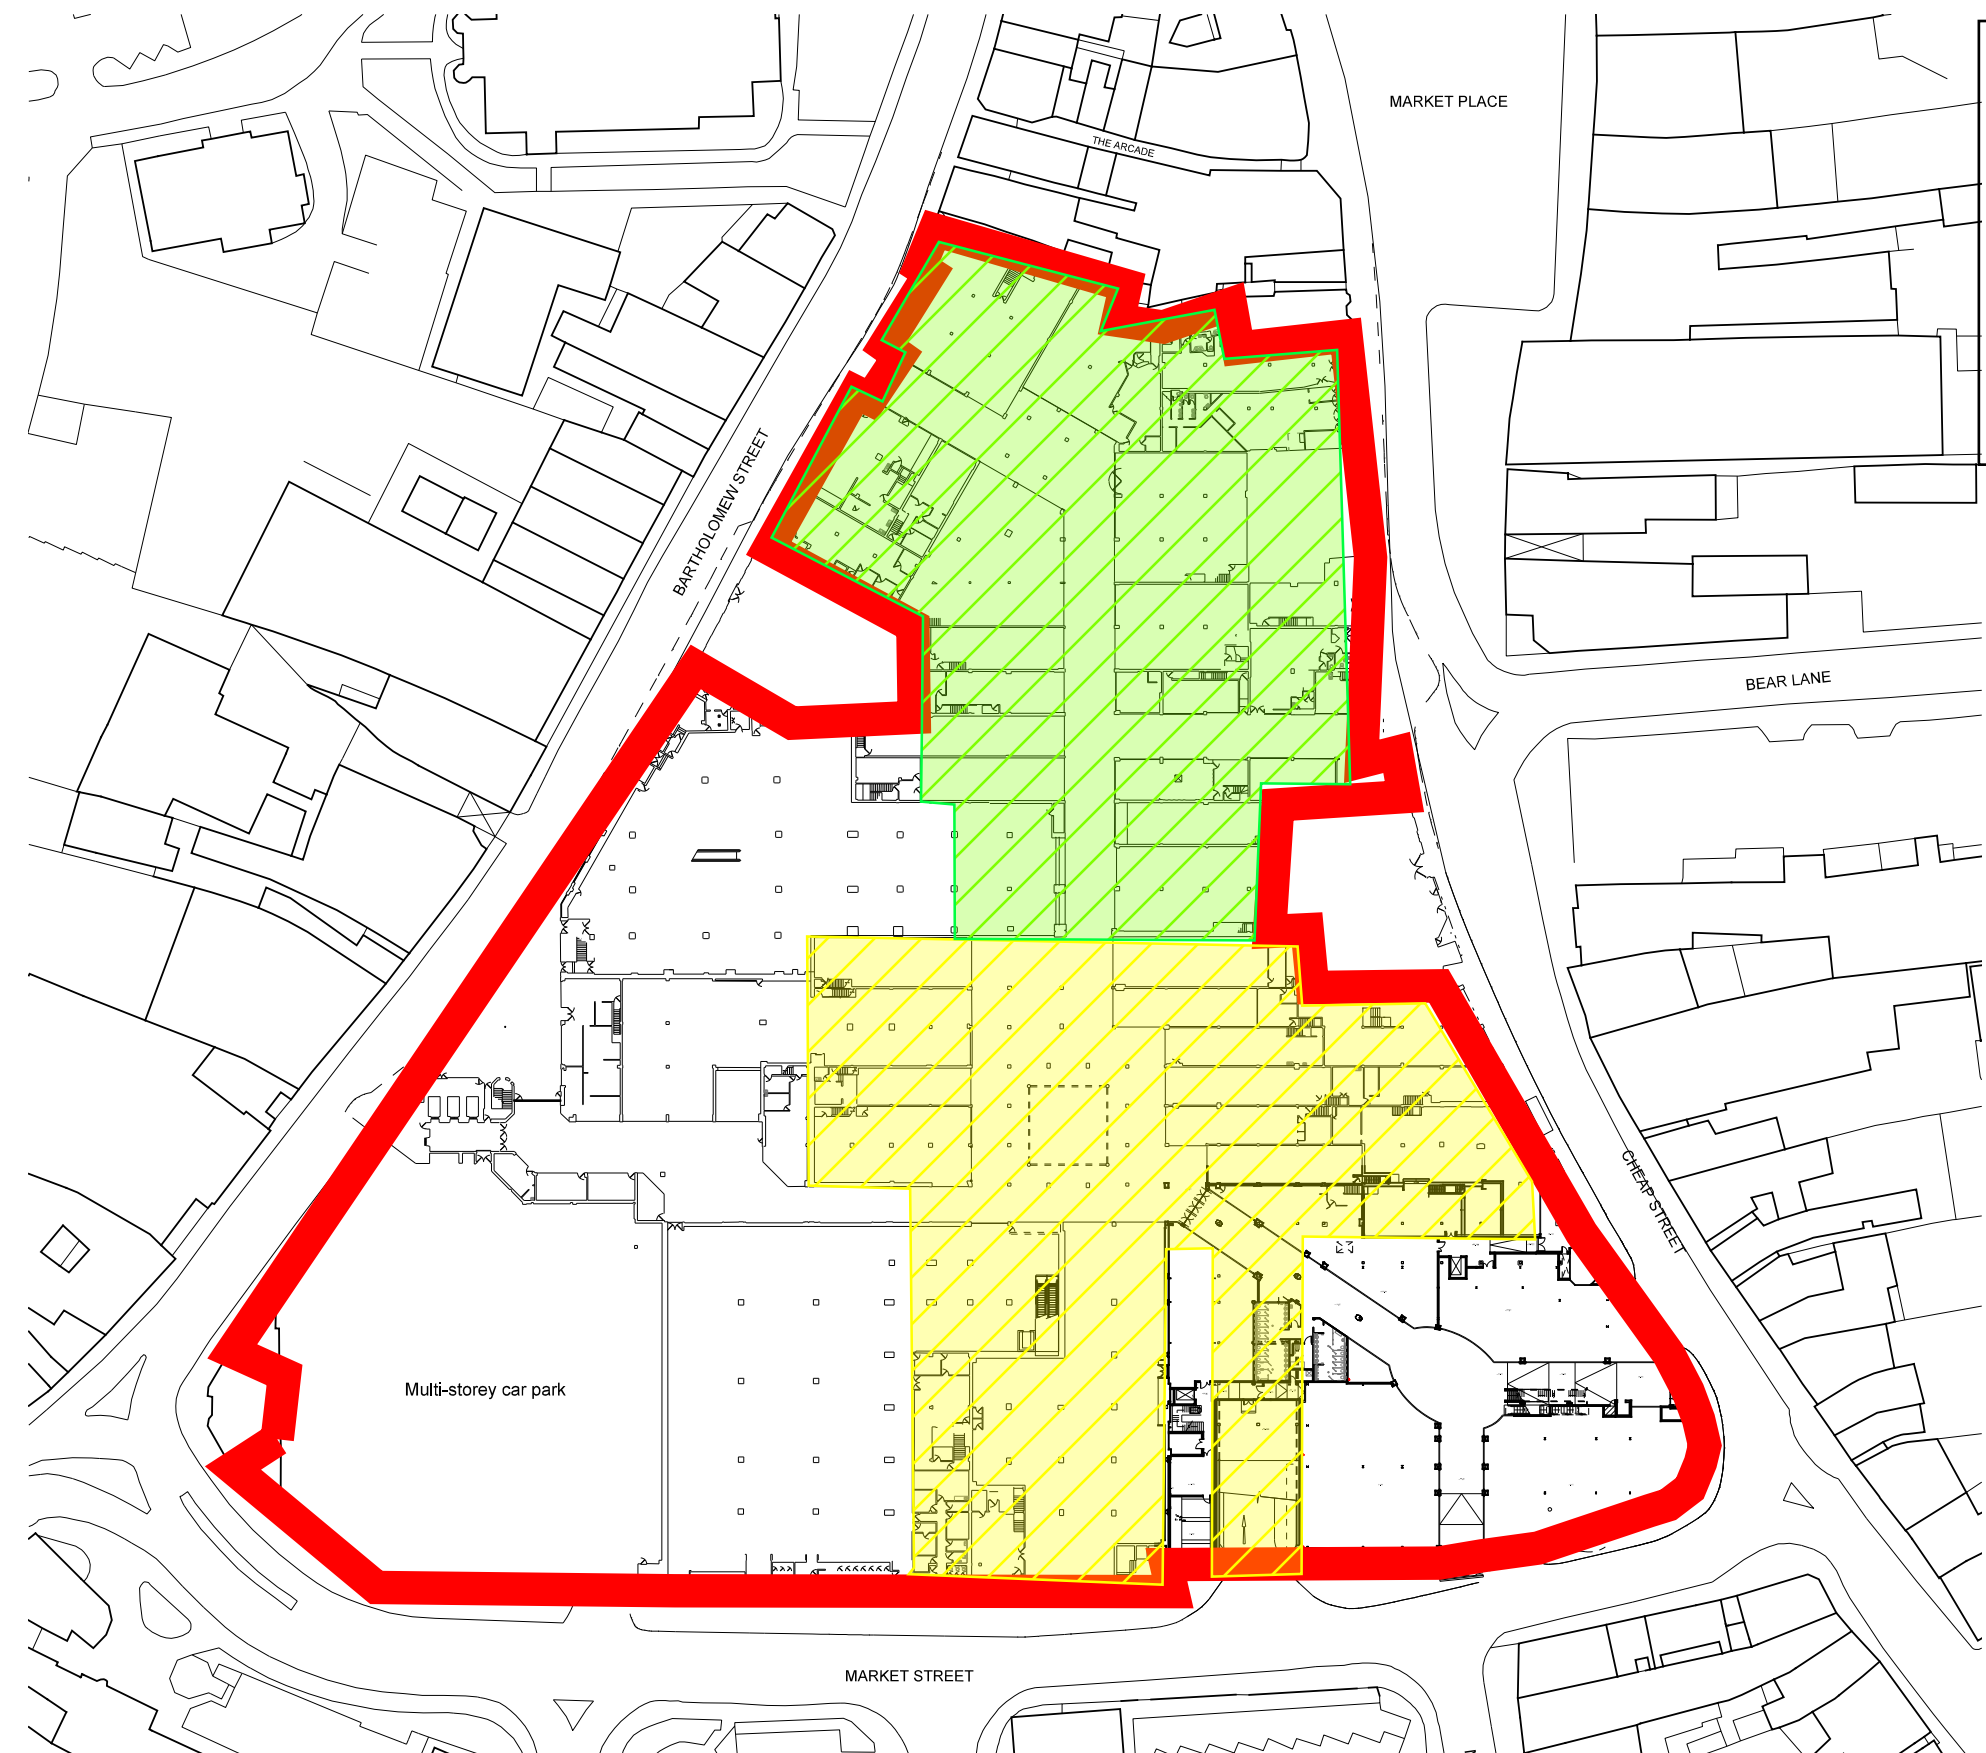
Phase 1

Phase 2

Phase 3

Phase 4

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	Project: <i>Kennet Centre</i>		Drawn: <i>CE</i>	Approved: <i>DA</i>	Job No: <i>4508</i>	Sheet No: <i>4508-SK-S-0001</i>	Rev: <i>P01</i>
	Title: <i>Timeline Sketches</i>		Scale at A3: <i>NTS</i>	Date: <i>04/10/2019</i>			
	Rev.	Revision Description	App	Date			



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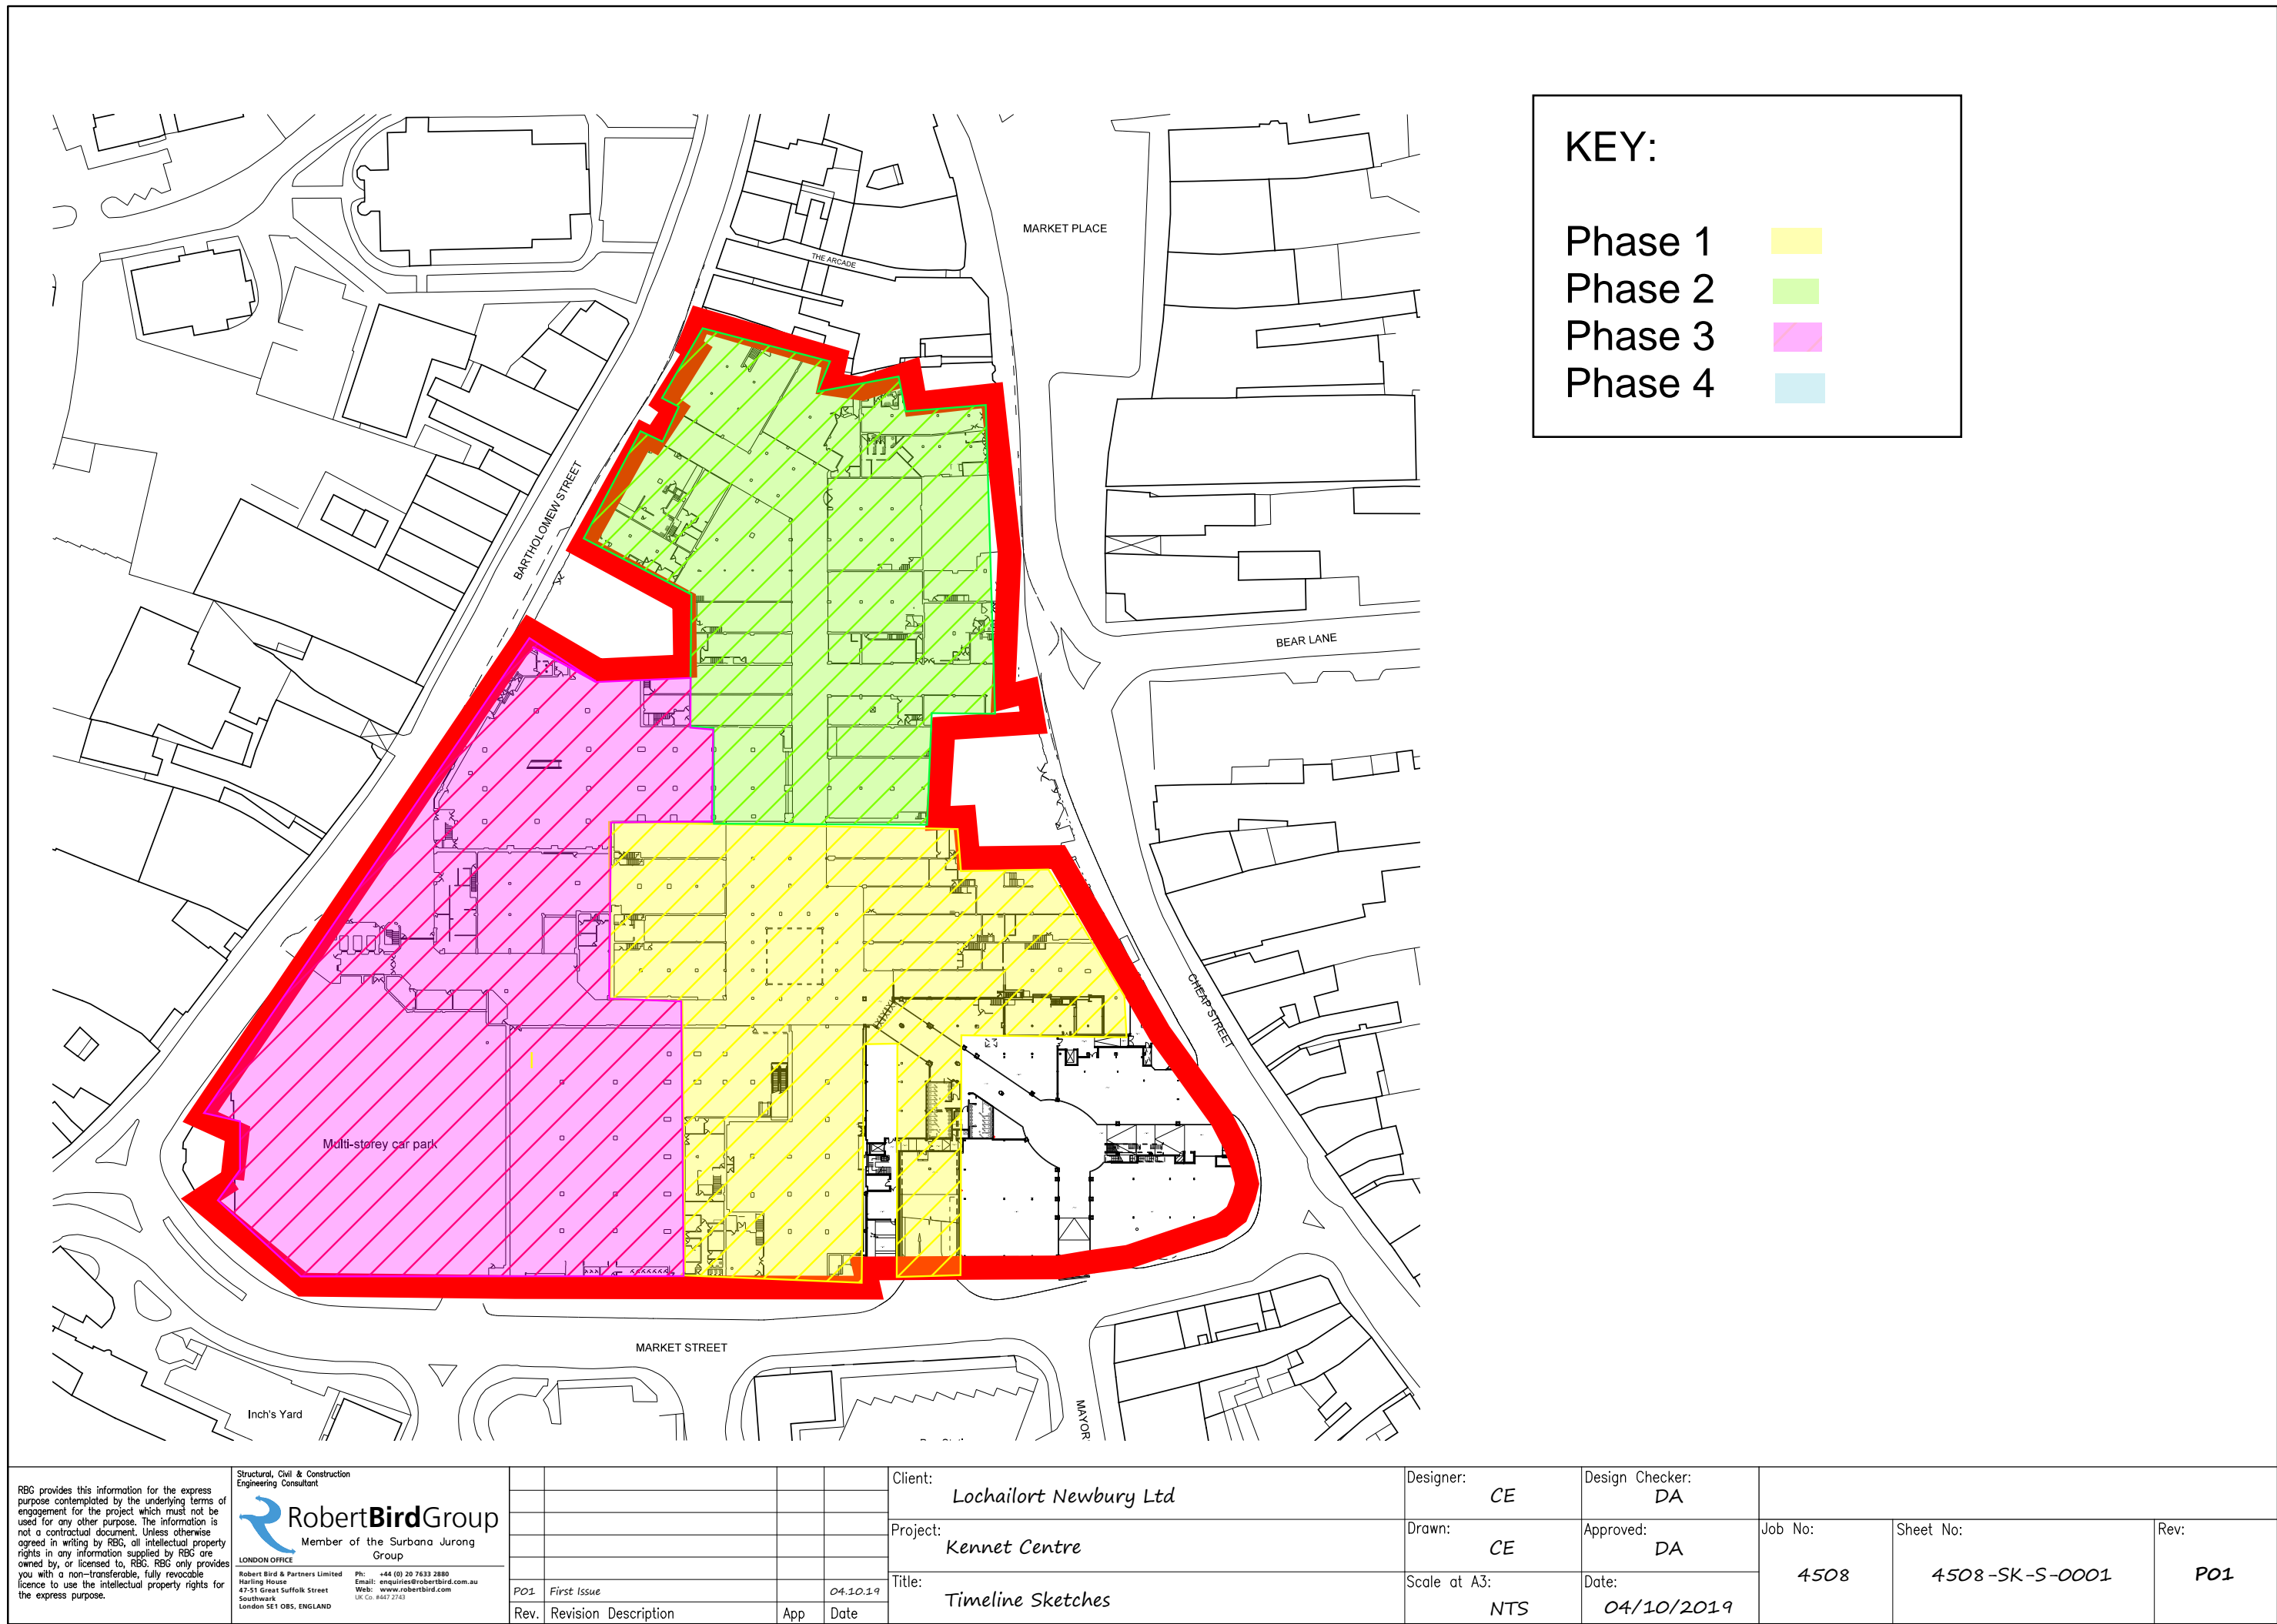
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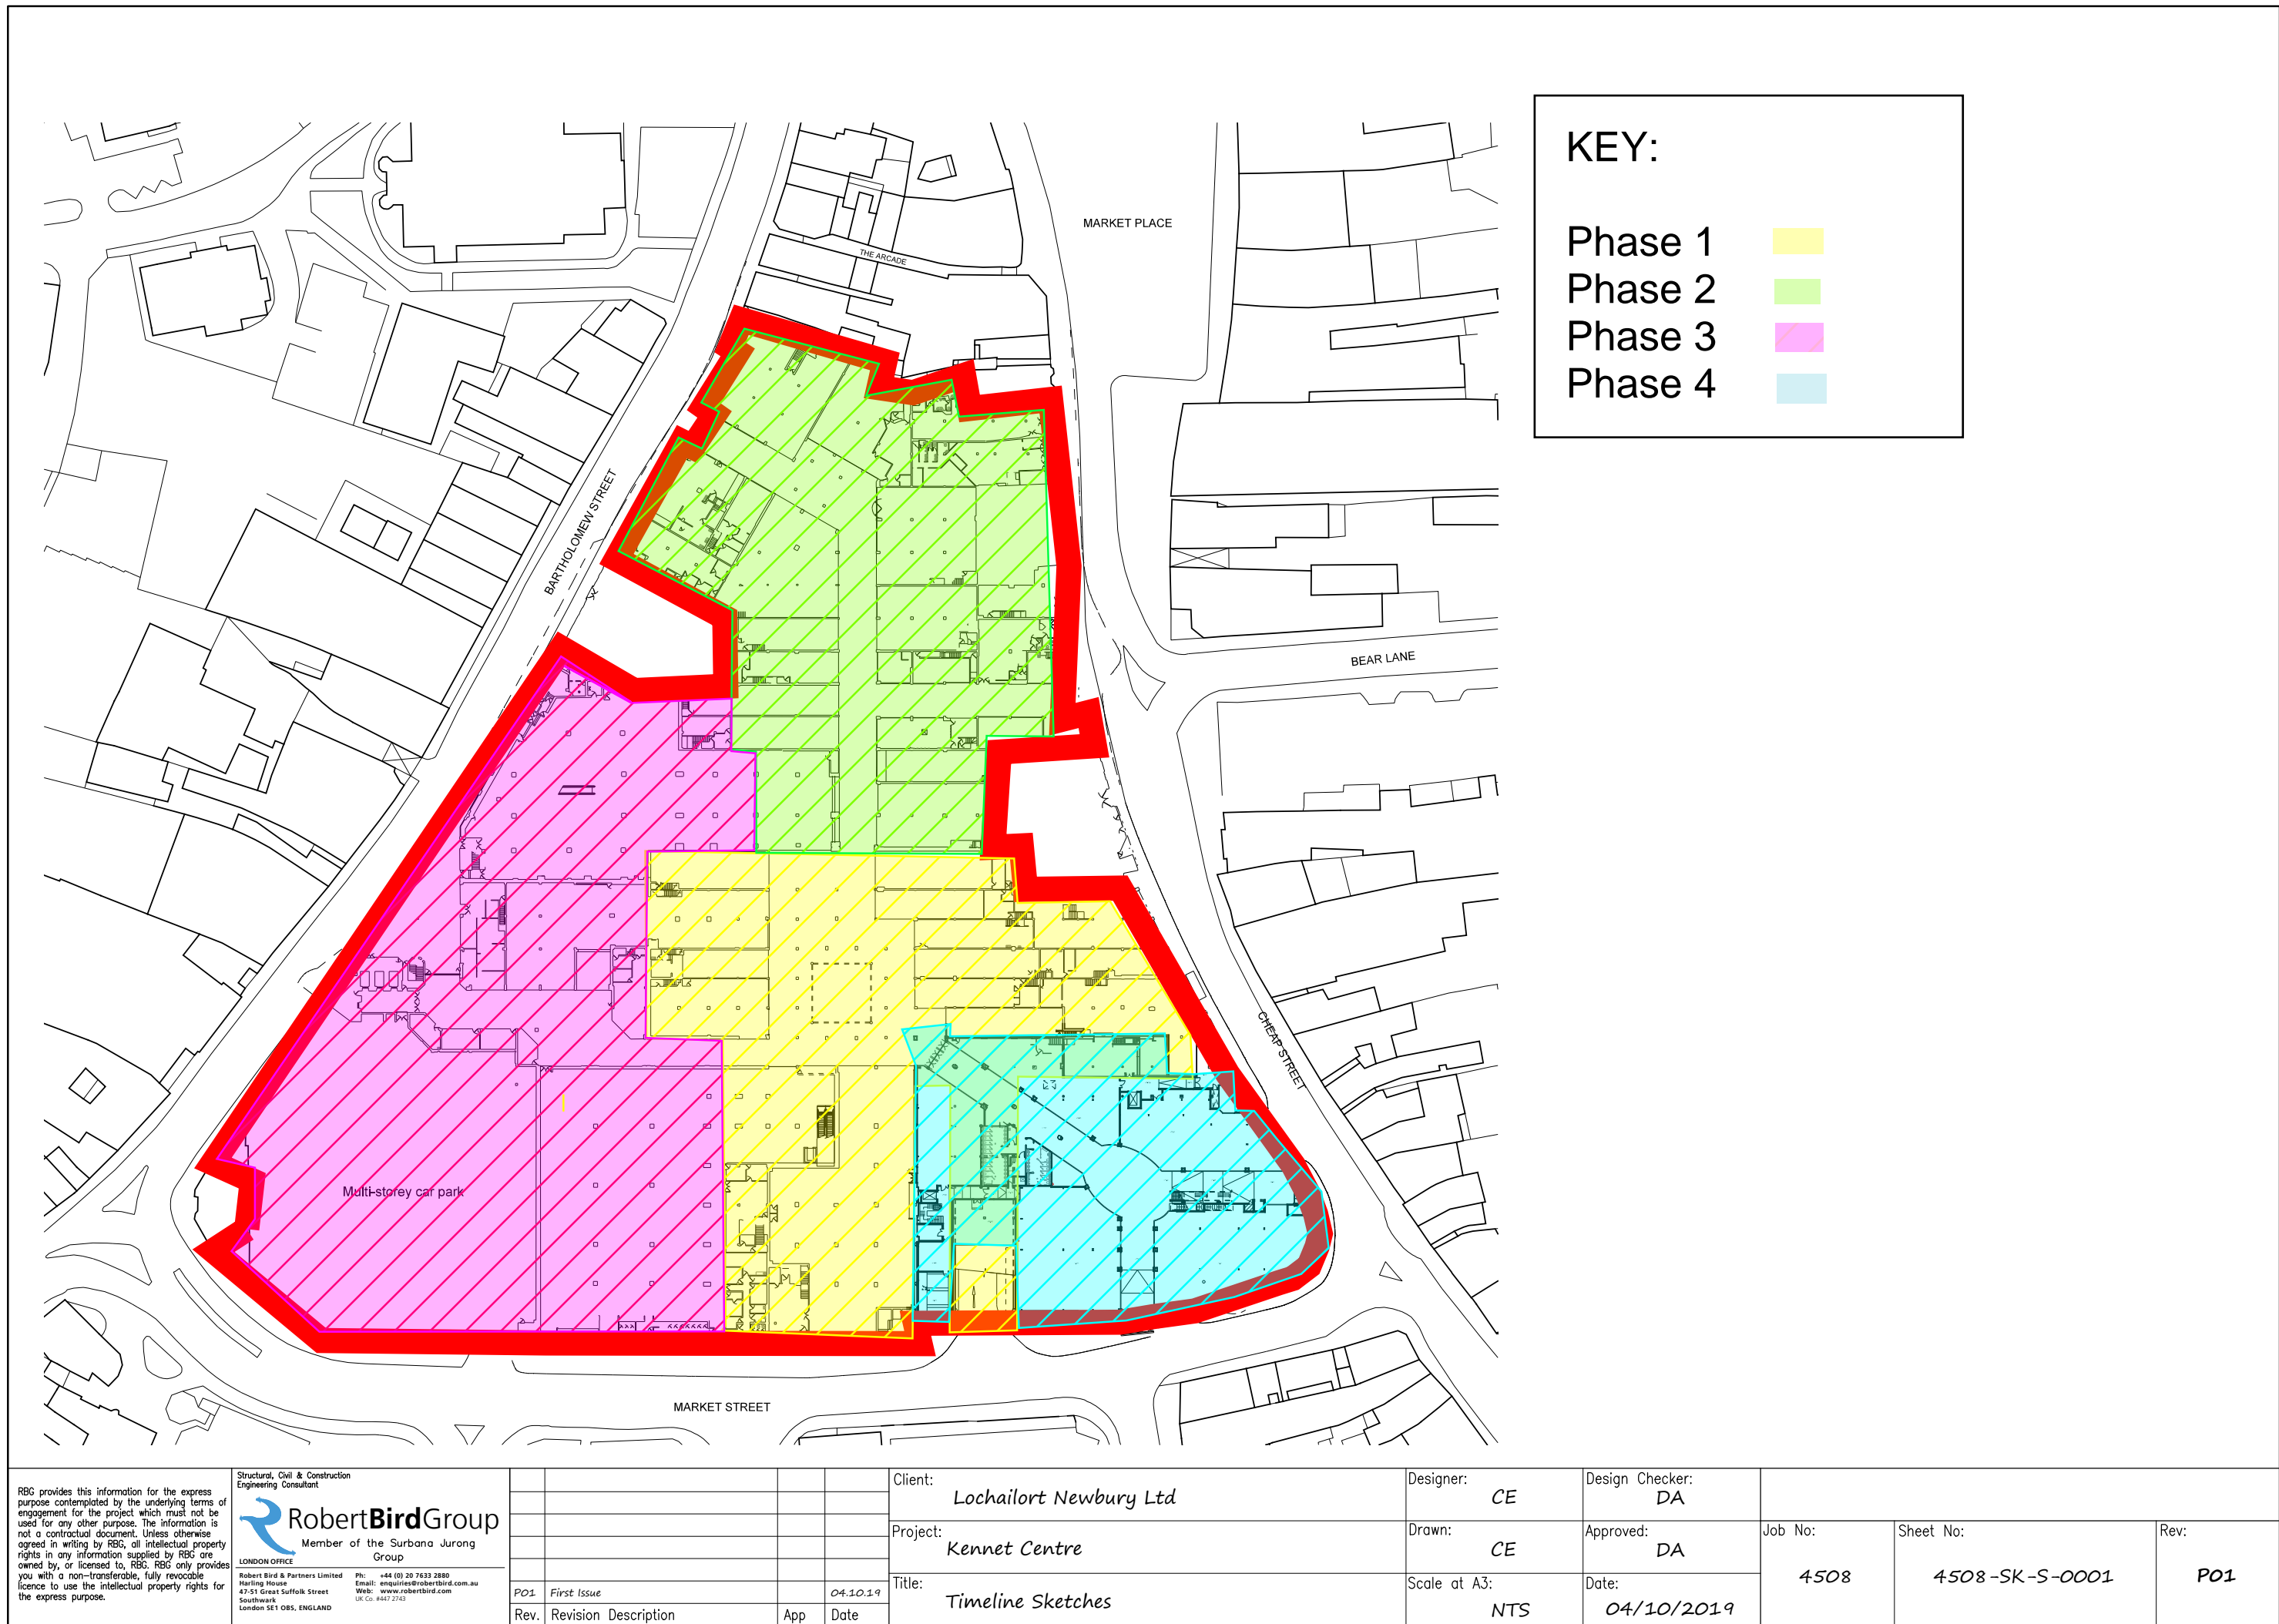
Phase 2

Phase 3

Phase 4

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						Project: <i>Kennet Centre</i>	Drawn: <i>CE</i>	Approved: <i>DA</i>	Job No:	Sheet No:	Rev:
						Title: <i>Timeline Sketches</i>	Scale at A3: <i>NTS</i>	Date: <i>04/10/2019</i>	<i>4508</i>	<i>4508-SK-S-0001</i>	<i>P01</i>
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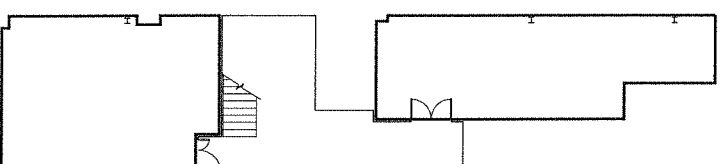
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				Title: <i>Timeline Sketches</i>		Scale at A3: <i>NTS</i>	Date: <i>04/10/2019</i>			
				PO1	First Issue					
Rev.	Revision	Description	App	Date						

Appendix B


Historic Drawings

NOTES

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2. Contractors must verify all figured dimensions on site before commencing any work or making any shop drawings.
3. This drawing is the sole copyright of RHM Planning and no part of it may be reproduced without the written consent of the above.
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FIRST FLOOR PLAN
UNIT V5 STORAGE



GROUND FLOOR PLAN
UNIT V5

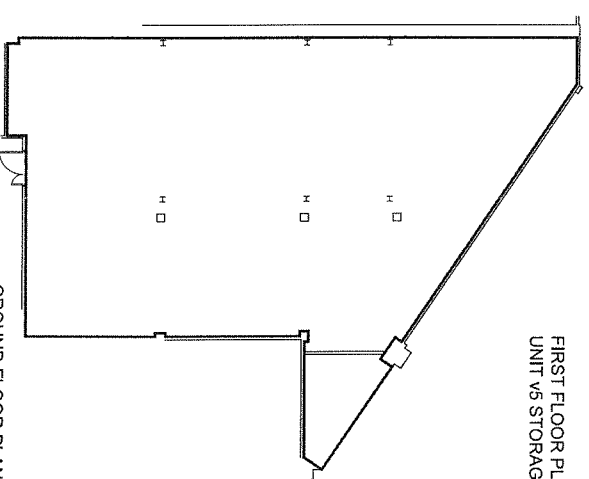

Site Location Plan
Scale 1:1250

DEMISE OF UNIT V5 THE KENNET CENTRE
LANDLORD OWNERSHIP

Floor Plan
Scale 1:200

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Client

Project


UNIT V5
THE KENNET CENTRE
NEWBURY

Drawing Title

LEASE PLAN

Drawing Number	Rev.	Scale
P0175 - 001	As Shown@A3	Scale
	Date	OCT 2013

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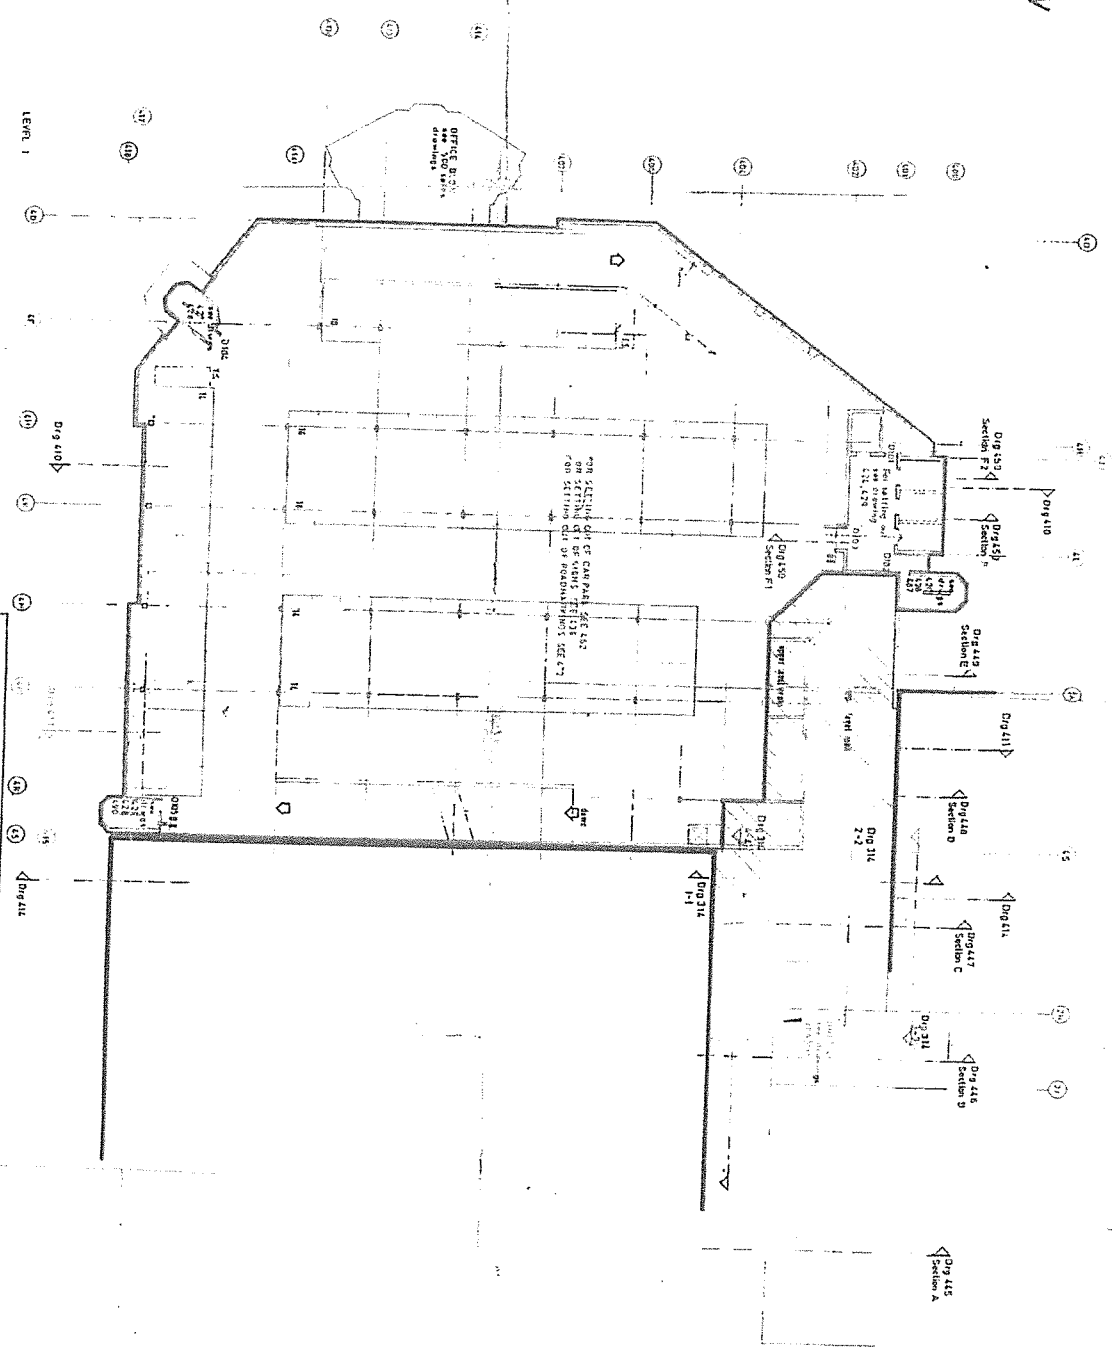
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KEY DRAWING ONLY
FOR DETAILS SEE DRAWING NO 462

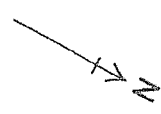REV 1 10/95 Perimeter reinforcement added
REV 2 11/95 Door numbers added
REV 3 10/96 Glass windows added
REV 4 11/95 Windows added

T. P. Bennett & Son
222 Main Avenue
Weymouth, MA 01978
Telephone 508-937-1121


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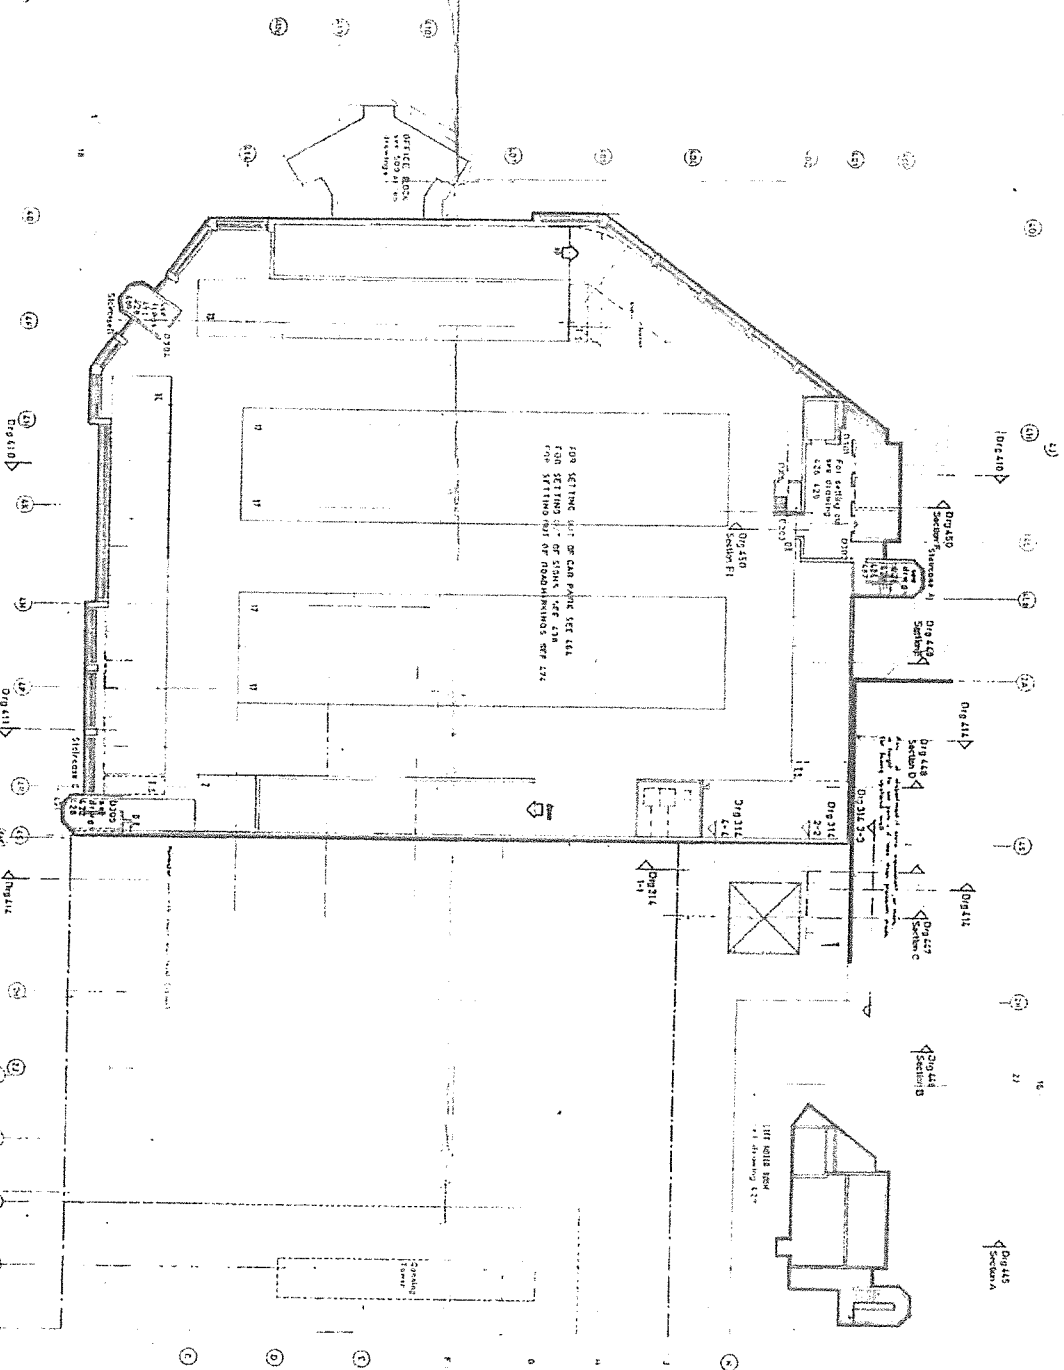
FOR DETAILS OF WALLS SEE DRAWING NO. 462
FOR DETAILS OF CARPENTRY SEE DRAWING NO. 462
FOR DETAILS OF ELECTRICAL SEE DRAWING NO. 462
FOR DETAILS OF MECHANICAL SEE DRAWING NO. 462
FOR DETAILS OF PLUMBING SEE DRAWING NO. 462
FOR DETAILS OF ROOFING SEE DRAWING NO. 462
FOR DETAILS OF SITEWORK SEE DRAWING NO. 462
FOR DETAILS OF UTILITIES SEE DRAWING NO. 462
FOR DETAILS OF FINISHES SEE DRAWING NO. 462
FOR DETAILS OF SPECIALTIES SEE DRAWING NO. 462

FOR DETAILS OF WALLS SEE DRAWING NO. 462
FOR DETAILS OF CARPENTRY SEE DRAWING NO. 462
FOR DETAILS OF ELECTRICAL SEE DRAWING NO. 462
FOR DETAILS OF MECHANICAL SEE DRAWING NO. 462
FOR DETAILS OF PLUMBING SEE DRAWING NO. 462
FOR DETAILS OF ROOFING SEE DRAWING NO. 462
FOR DETAILS OF SITEWORK SEE DRAWING NO. 462
FOR DETAILS OF UTILITIES SEE DRAWING NO. 462
FOR DETAILS OF FINISHES SEE DRAWING NO. 462
FOR DETAILS OF SPECIALTIES SEE DRAWING NO. 462

10/10/10



KEY DRAWING ONLY
FOR DETAILS SEE DRAWING 464

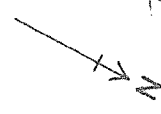

FROM HEIRATS OF MALLS. SEE ONLY ADS
 MEDICAL, 300-355
 FROM HEIRATS OF CAR PARK. SEE ONLY ADS
 MEDICAL, 300-355
 FROM HEIRATS OF OFFICE. SEE ONLY ADS
 MEDICAL, 300-355
 FROM HEIRATS OF SUPERMARKET. SEE ONLY ADS
 MEDICAL, 300-355

FOR TYPICAL ELEVATIONAL DETAILS SEE 415
FOR TYPICAL SECTIONAL DETAILS SEE 416, 417
FOR OPENING DETAILS SEE 460, 461
OR WINDOWS SEE 462, 463, 464, 465

REF: 112165	Personnel file of subject and his wife, Margaret, described in the above report.	SEARCHED	INDEXED
REF: 2 123456	Same marriage, same subject left wife's home in 1947 and is still in California. (SAC)	SERIALIZED	FILED
REF: 1 123456	Same marriage, subject left wife's home in 1947 and is still in California. (SAC)	SERIALIZED	FILED
T. R. BARNETT and SON 1000 N. Hudson, WICHITA, KS Phone 2-2881		SEARCHED _____ INDEXED _____ SERIALIZED _____ FILED _____ MAR 1950 FBI - KANSAS CITY	
5880 CP SK 403 146		SEARCHED _____ INDEXED _____ SERIALIZED _____ FILED _____ MAR 1950 FBI - KANSAS CITY	

SECTION BETWEEN GRIDS 6 G&GJ

CAMPARK

615

616

617

618 18e

19c

20e

21e

222

Z3e

242

SECTION ON GRID 6C

MSCP

[illegible]

[illegible]

SECTION THRO' PLANTER 1:10

This technical drawing shows a cross-section of a wall assembly. The wall consists of several horizontal layers. On the left side, there are vertical dimension lines indicating heights of 150, 180, and 190 units. At the top, there are horizontal dimension lines indicating widths of 230, 100, 60, and 20 units. A small rectangular feature is shown protruding from the main wall body. To the right of the wall, there is a hatched area representing another material or structure.

SECTION 1: 20
THRO' MURAL WALL

[illegible]

MSCP

THE NEW STORAGE AREA REQUIRES AN IMPOSED LOAD OF 5 kN/m², WHICH IS HIGHER THAN THE 3 kN/m² IMPOSED LOAD OF THE EXISTING STRUCTURE. THE EXISTING STRUCTURE MUST BE STRENGTHENED TO SUPPORT THE INCREASE IN IMPOSED LOAD AND ANY OTHER ADDITIONAL LOADS DUE TO FLOOR FINISHES THAT MAY BE REQUIRED. THE EXISTING SLAB STRUCTURE MUST ALSO BE CHECKED FOR ANY LOCAL EFFECTS SUCH AS CONCENTRATED LOADS DUE TO WHEELS.

NEW STORAGE AREA
(AT FIRST FLOOR)


NEW DUMB WAITERS


NEW STRUCTURE REQUIRED
IN THIS AREA AS NOTED ON
SKETCH:
1014343 SL 2017 06 05 Sk001

Cundall

Project:
Revolution Bar,
Kennet Shopping Centre,
Newbury

STRUCTURAL SKETCH:
1014343_SL_2017_06_05_Sk002

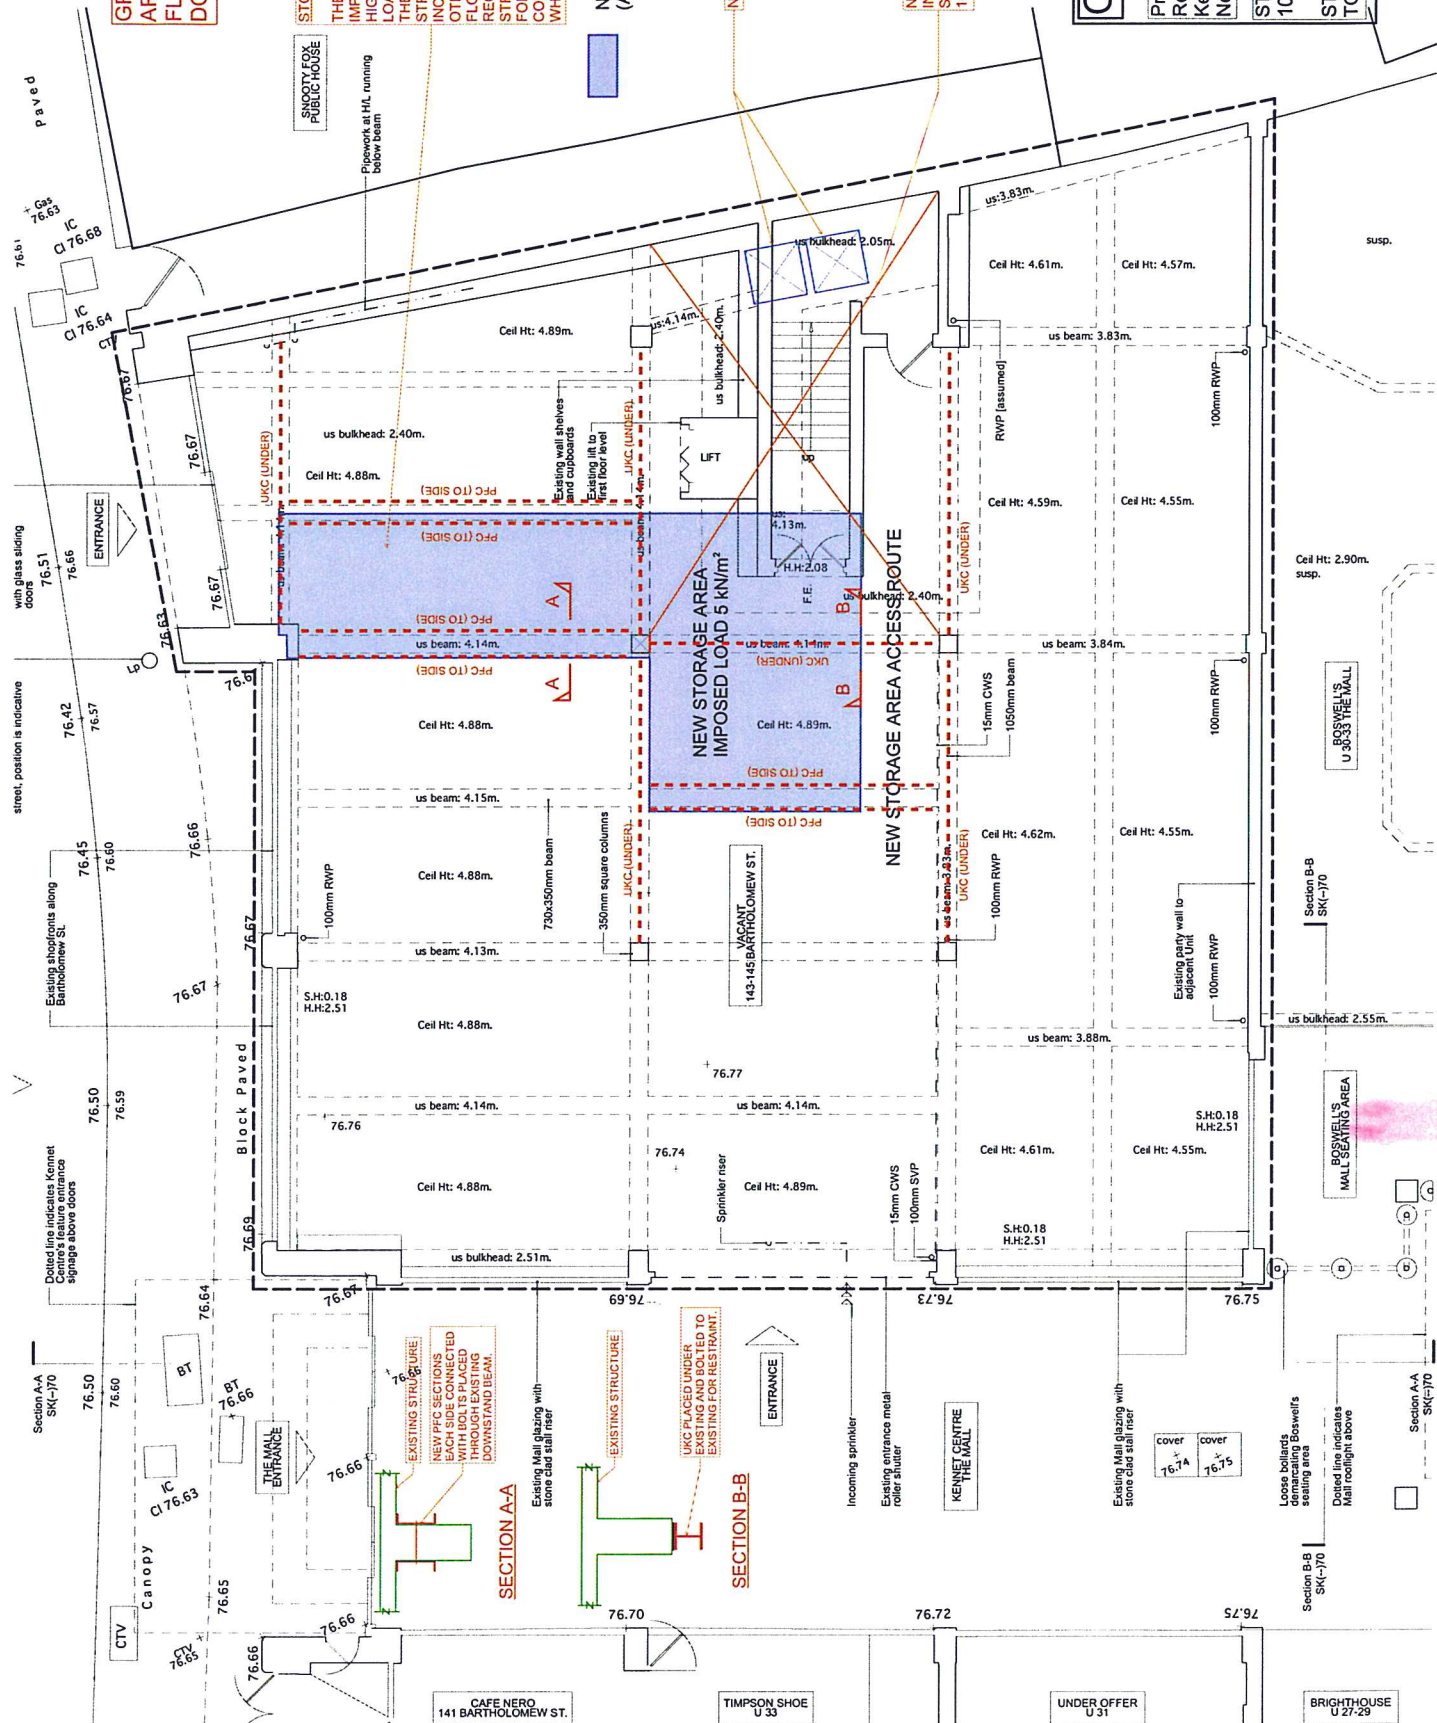

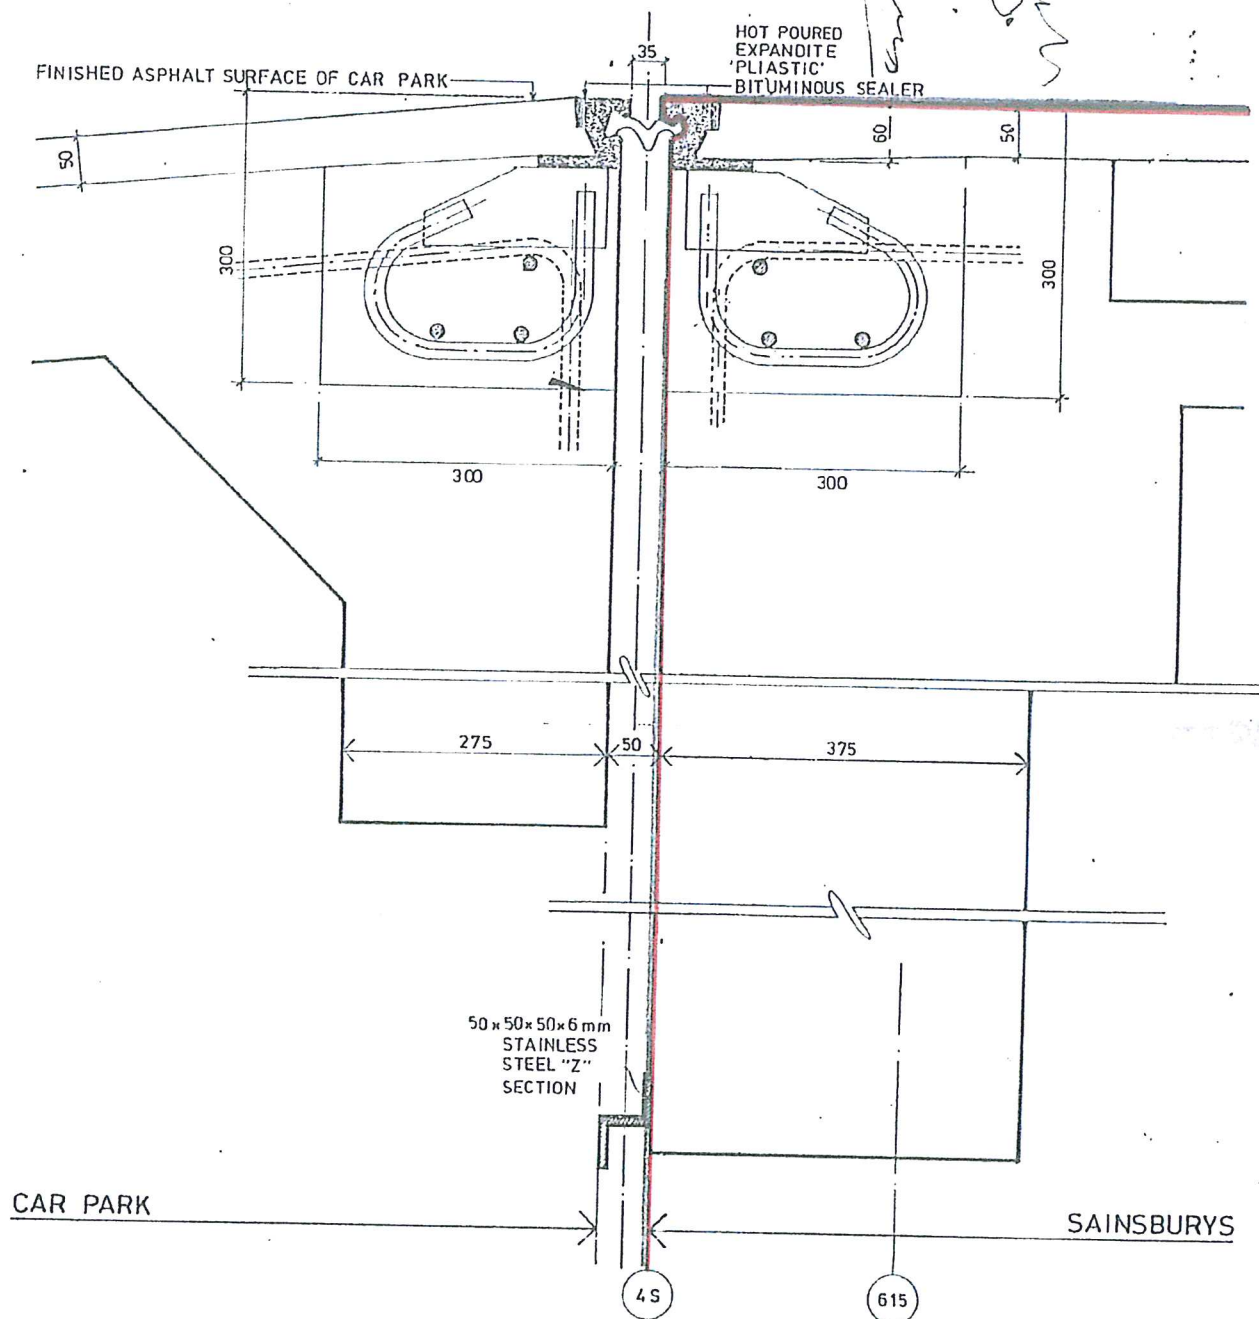

REV D 24/7/85 Detail amended

MSCP

contract title
KENNET CENTRE
NEWBURY PHASE 3

T P Bennett & Son
Chartered Architects
262 High Holborn WC1V 7DU
Telephone 01 405 9277

drawing title
MAGEBA JOINT CONSTRUCTION
LEVEL 2 CAR PARK / SAINSBURY
ROOF

contract drawing number ©
5880 CP SK 439

scale
1:5

date
APR. 85

drawn
P K

revision


D

2007


P_LAN NO 1

A Revised
03/06/2009

Site Plan .500

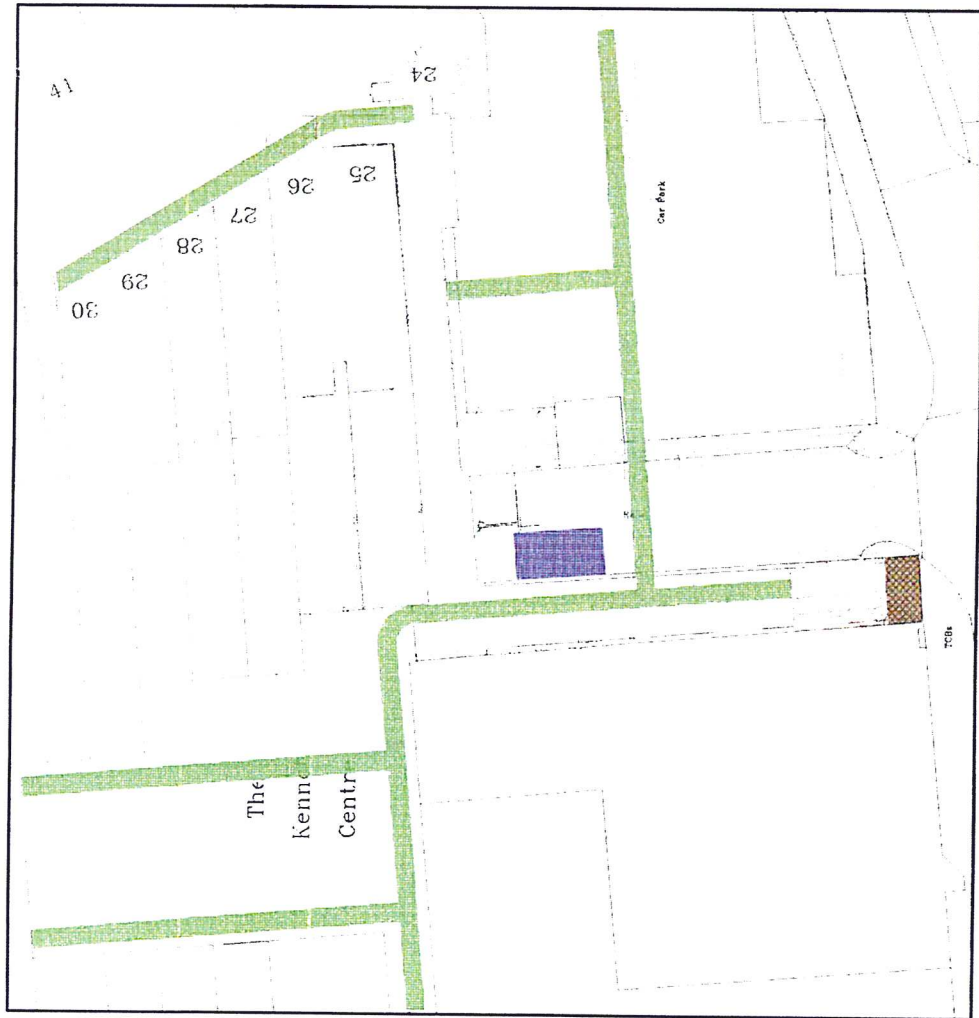

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5	1	1
6	1	1
7	1	1
8	1	1
9	1	1
10	1	1
11	1	1
12	1	1
13	1	1
14	1	1
15	1	1
16	1	1
17	1	1
18	1	1
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20	1	1
21	1	1
22	1	1
23	1	1
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26	1	1
27	1	1
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91	1	1
92	1	1
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98	1	1
99	1	1
100	1	1

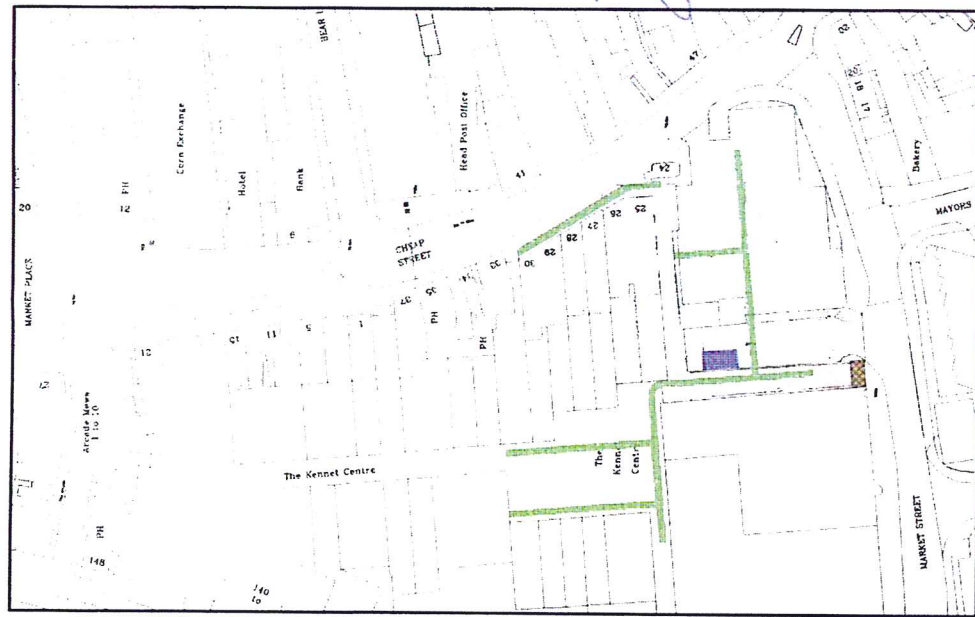


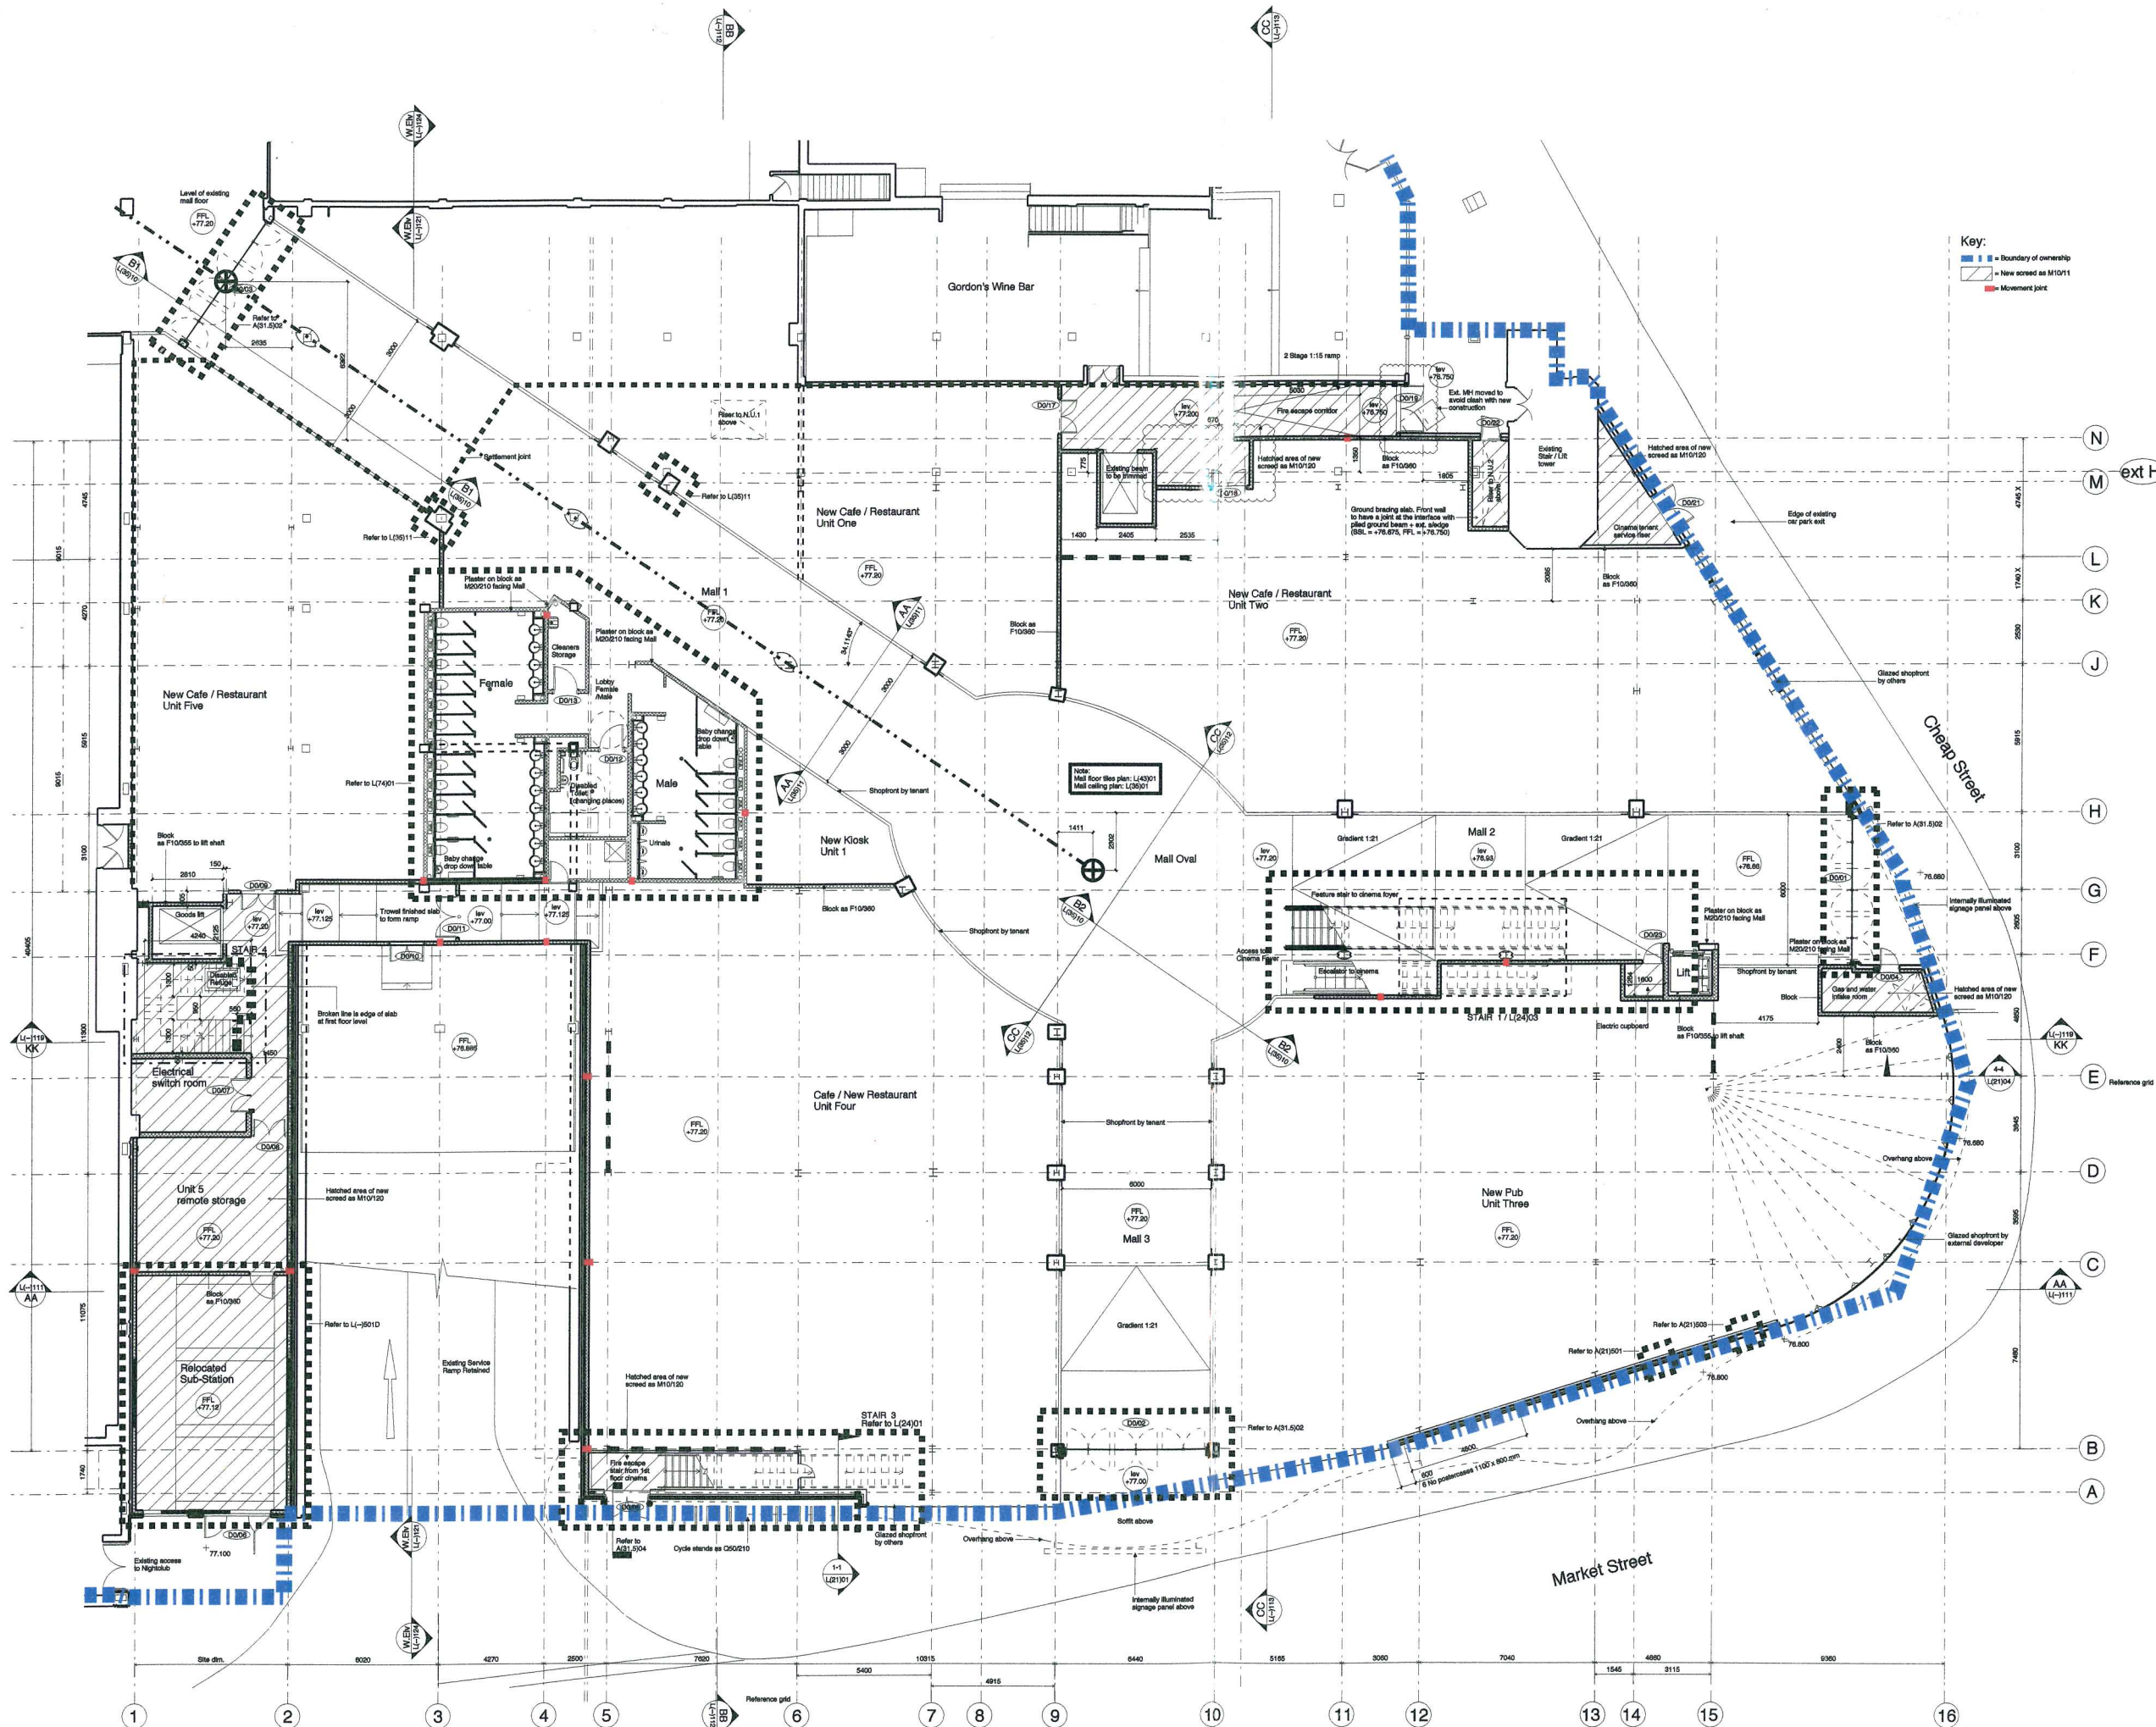
2018

Substation shown PINK
Cable Easements shown GREEN
Access shown BROWN
Access with cables shown BROWN HATCHED BLACK
Land to be relinquished shown BLUE

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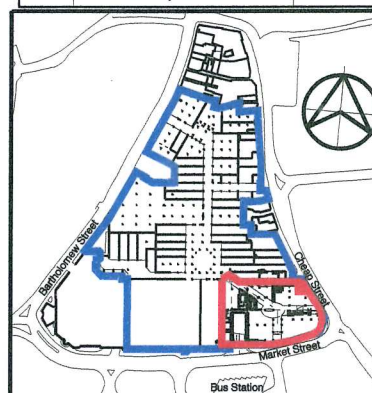
Scottish and Southern Energy plc
Registered in Scotland No 111118
Registered Office: Livermoor House
200 Dunkeld Road
Perth, PH1 2AQ


Scottish and Southern Energy plc
 Newbury Cinema Complex
 Market Place
 Newbury
 PRN - 28525



Dimensions are not to be scaled from this drawing.
This drawing is based on current available information and should not be relied on as accurate measurements of usable space.
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Revision	Notes	Date
L	General amendment, amendment to lift shafts, ramp added to comply with change in levels.	11/03/08
M	Minor adjustments Wall on gridline 2 moved by 400mm	09/04/08
N	Paving re-hatch; Electric cupboard shown; Riser to Unit 2 enlarged; Rearranged north fire exit corridor; Street hatched;	13/05/08
O	Minor adjustments	13/06/08
P	General amendments	22/09/08
Q	Existing MH added and walls amended	01/10/08
R	New construction around existing MH amended following discussions on site	09/10/08
S	Drawing amended following comments received from the Structural Engineer	28/10/08
T	Alterations at Infill building and beneath ramp	12/12/08
U	Alterations near D0/19	06/01/09
V	Columns co-ordinated with latest ABA plans	20/01/09
W	Setting out of Mall 1	27/02/09
X	Block movement joints amended	24/03/09



CONSTRUCTION ISSUE



Project
Proposed Cinema Development
The Kennet Centre
Newbury

Title
Proposed Ground Floor Plan

Scale 1:125 @ A1 1:250 @ A3	Date 20/03/2007
Drawn by ADS	Checked By CP
Drawing No. 2572/L--101	Revision X

The Colman Partnership Limited
27 Harcourt Street
London W1H 4HP
Telephone : 020 7535 2040
Facsimile : 020 7535 2041
email: projects@colmanarchitects.co.uk

www.colmanarchitects.co.uk

CAD Filename: \\Top1\architects\TCP\Jobs\2572\2572 SHTSL--101.dgn
24/03/2009

IMPORTANT
THIS DRAWING IS RELEVANT

FOR ALL OTHERS TO
THE

NOTES

For Legend See Drg No 2142/P25

This drawing supersedes
Drg No 2142/P23

Stormwater Drainage
● Road gully and trapped gully
Foul Drainage

ALL DIMENSIONS IN MILLIMETRES
HEIGHTS IN METRES

D	GRID ADDED TO MH 109	16/11/77	R.P.
C	MH 104A INSTEAD ADDED	27/7/77	R.P.
B	GULLY / RWP ADDED COLUMN H.30	14/7/77	R.P.
A	2 50 TO ADD FOR SPREADER	24/6/77	R.P.
REV	DESCRIPTION	DATE	BY

NEWBURY TOWN CENTRE
DEVELOPMENT (i)

ground-floor DRAINAGE
Grid Lines 16-38


T. P. BENNETT & SON
Chartered Architects
43 Bloomsbury Square W.C1

ARTHUR LING ASSOCIATES
Consultant Architects
11 Russell Place NOTTINGHAM

Scale 1:200
Date 21/7/77
Drawn
Checked

Drg. No.
2142/P26


Revision
D

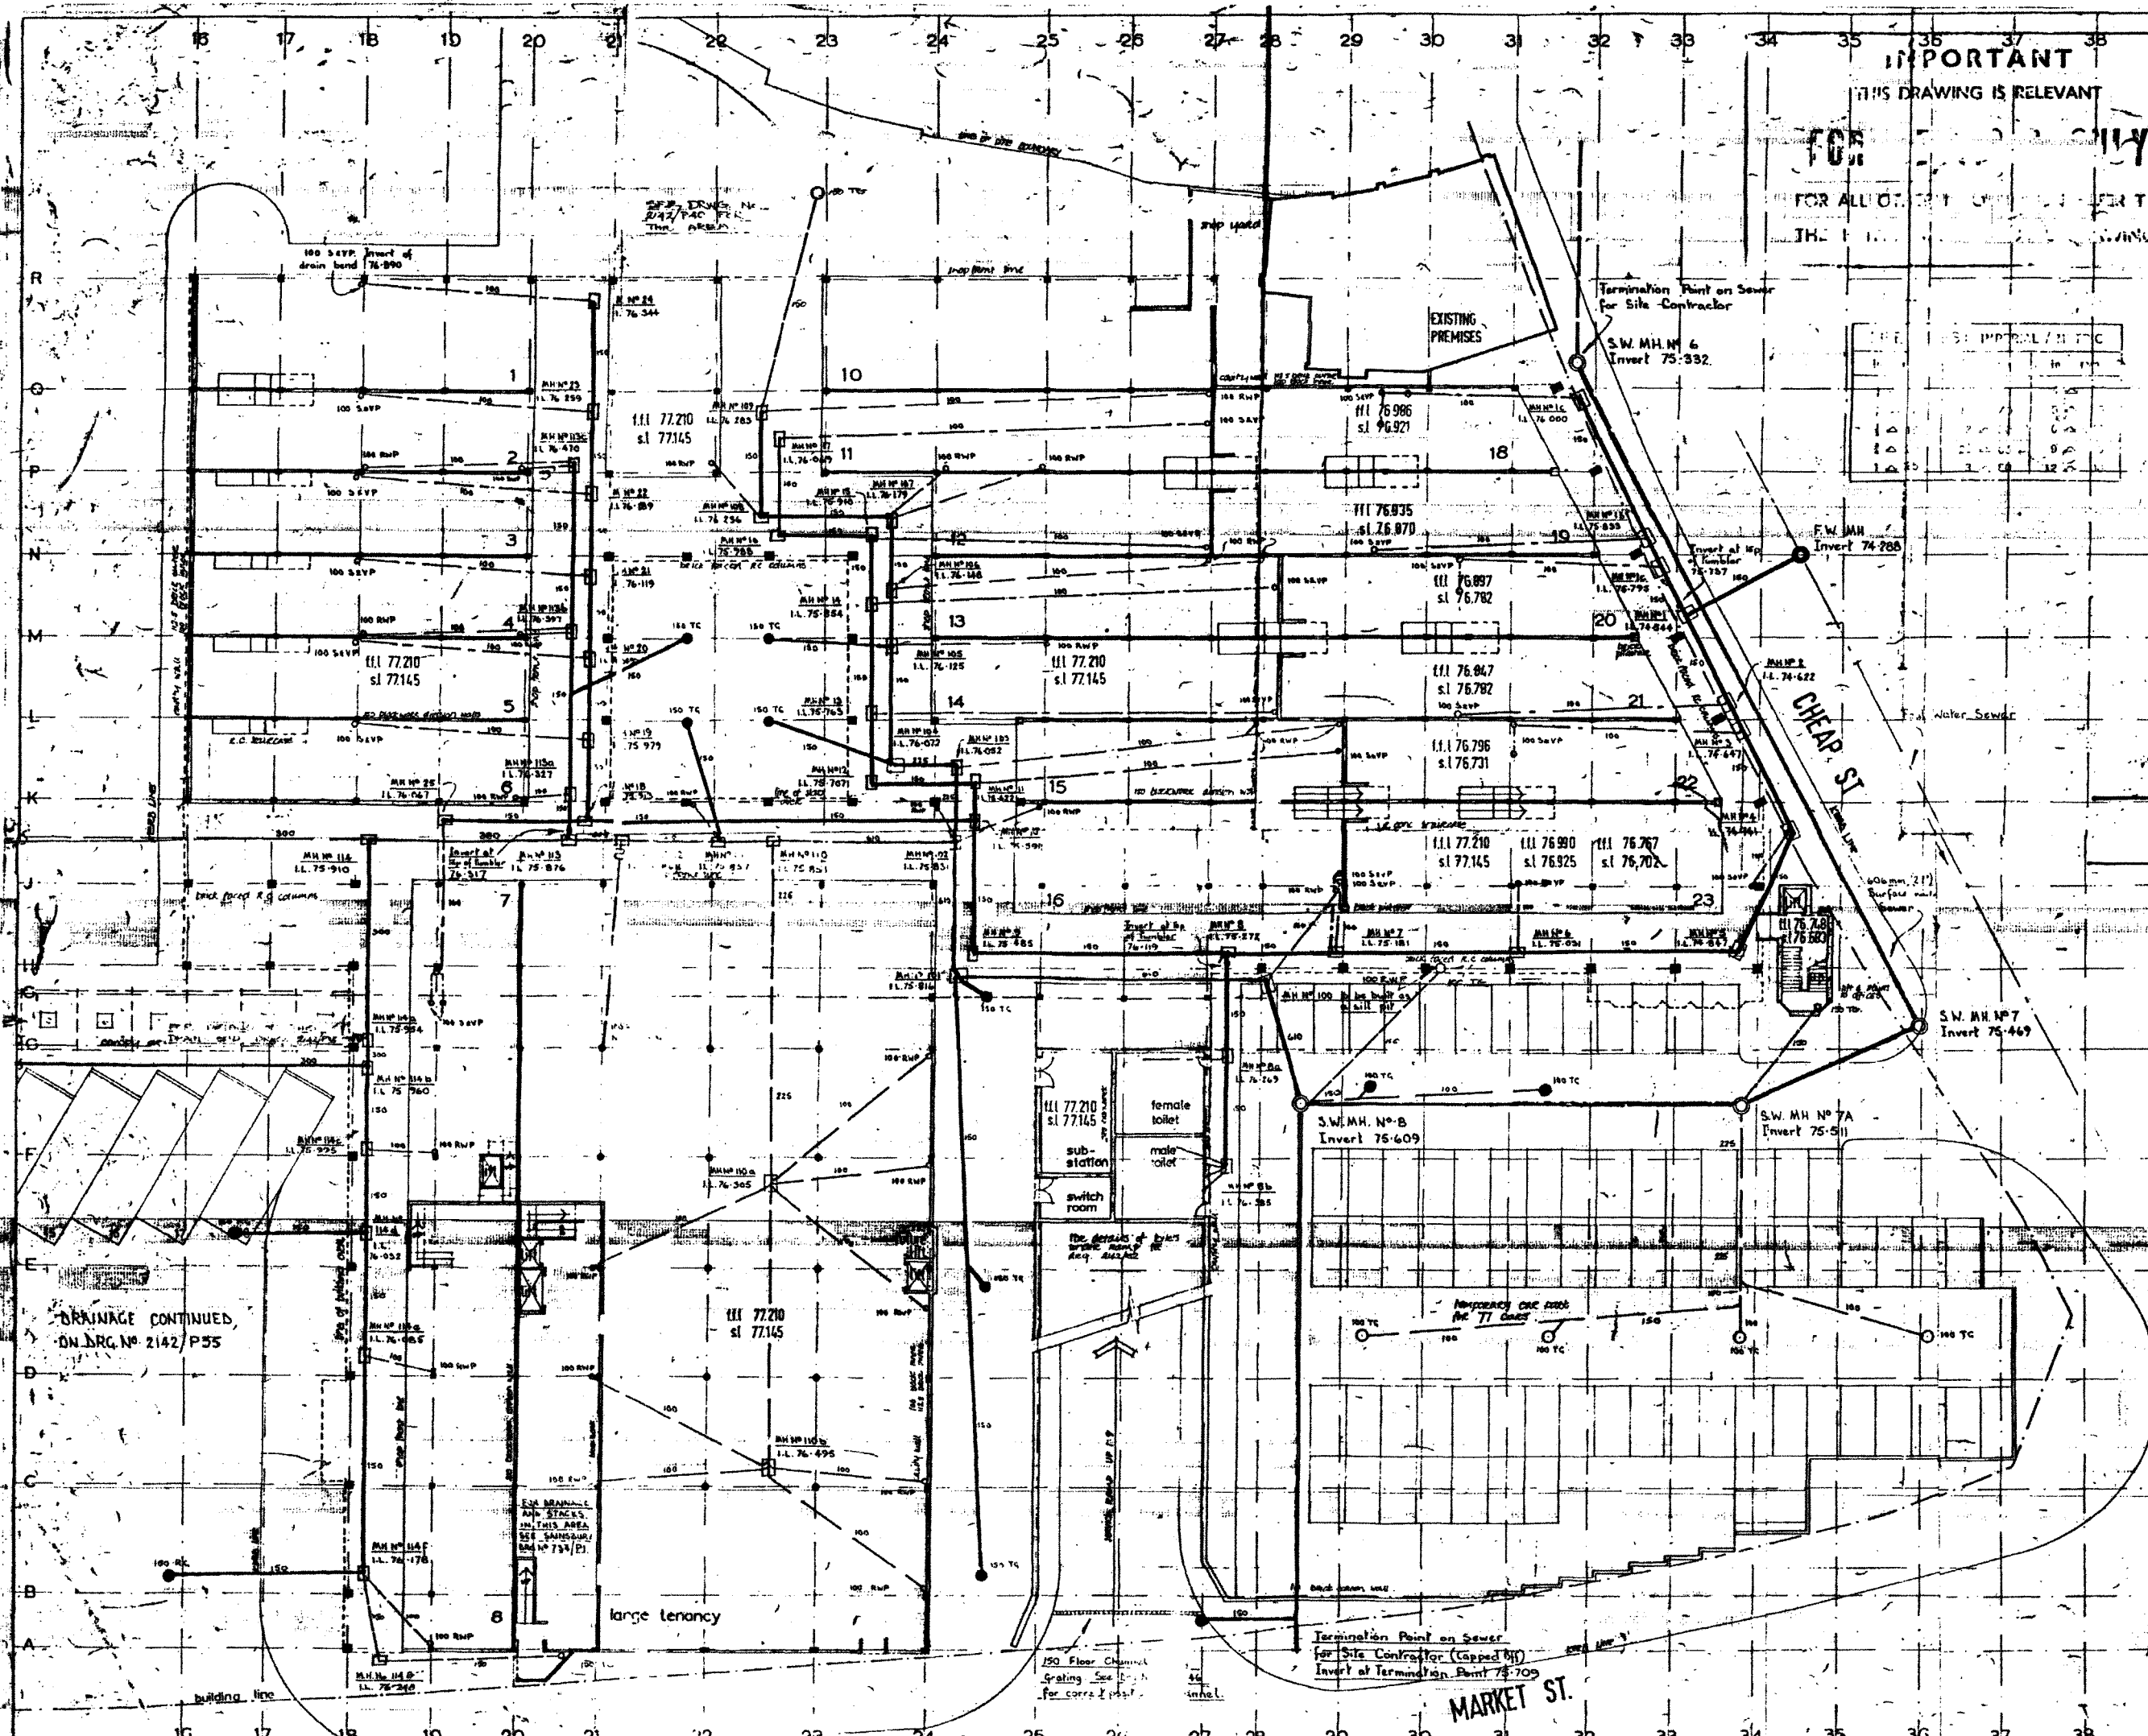

DRAINAGE CONTINUED,
ON DRG. NO 2142/P25

MARKET ST.

CHEAP ST.

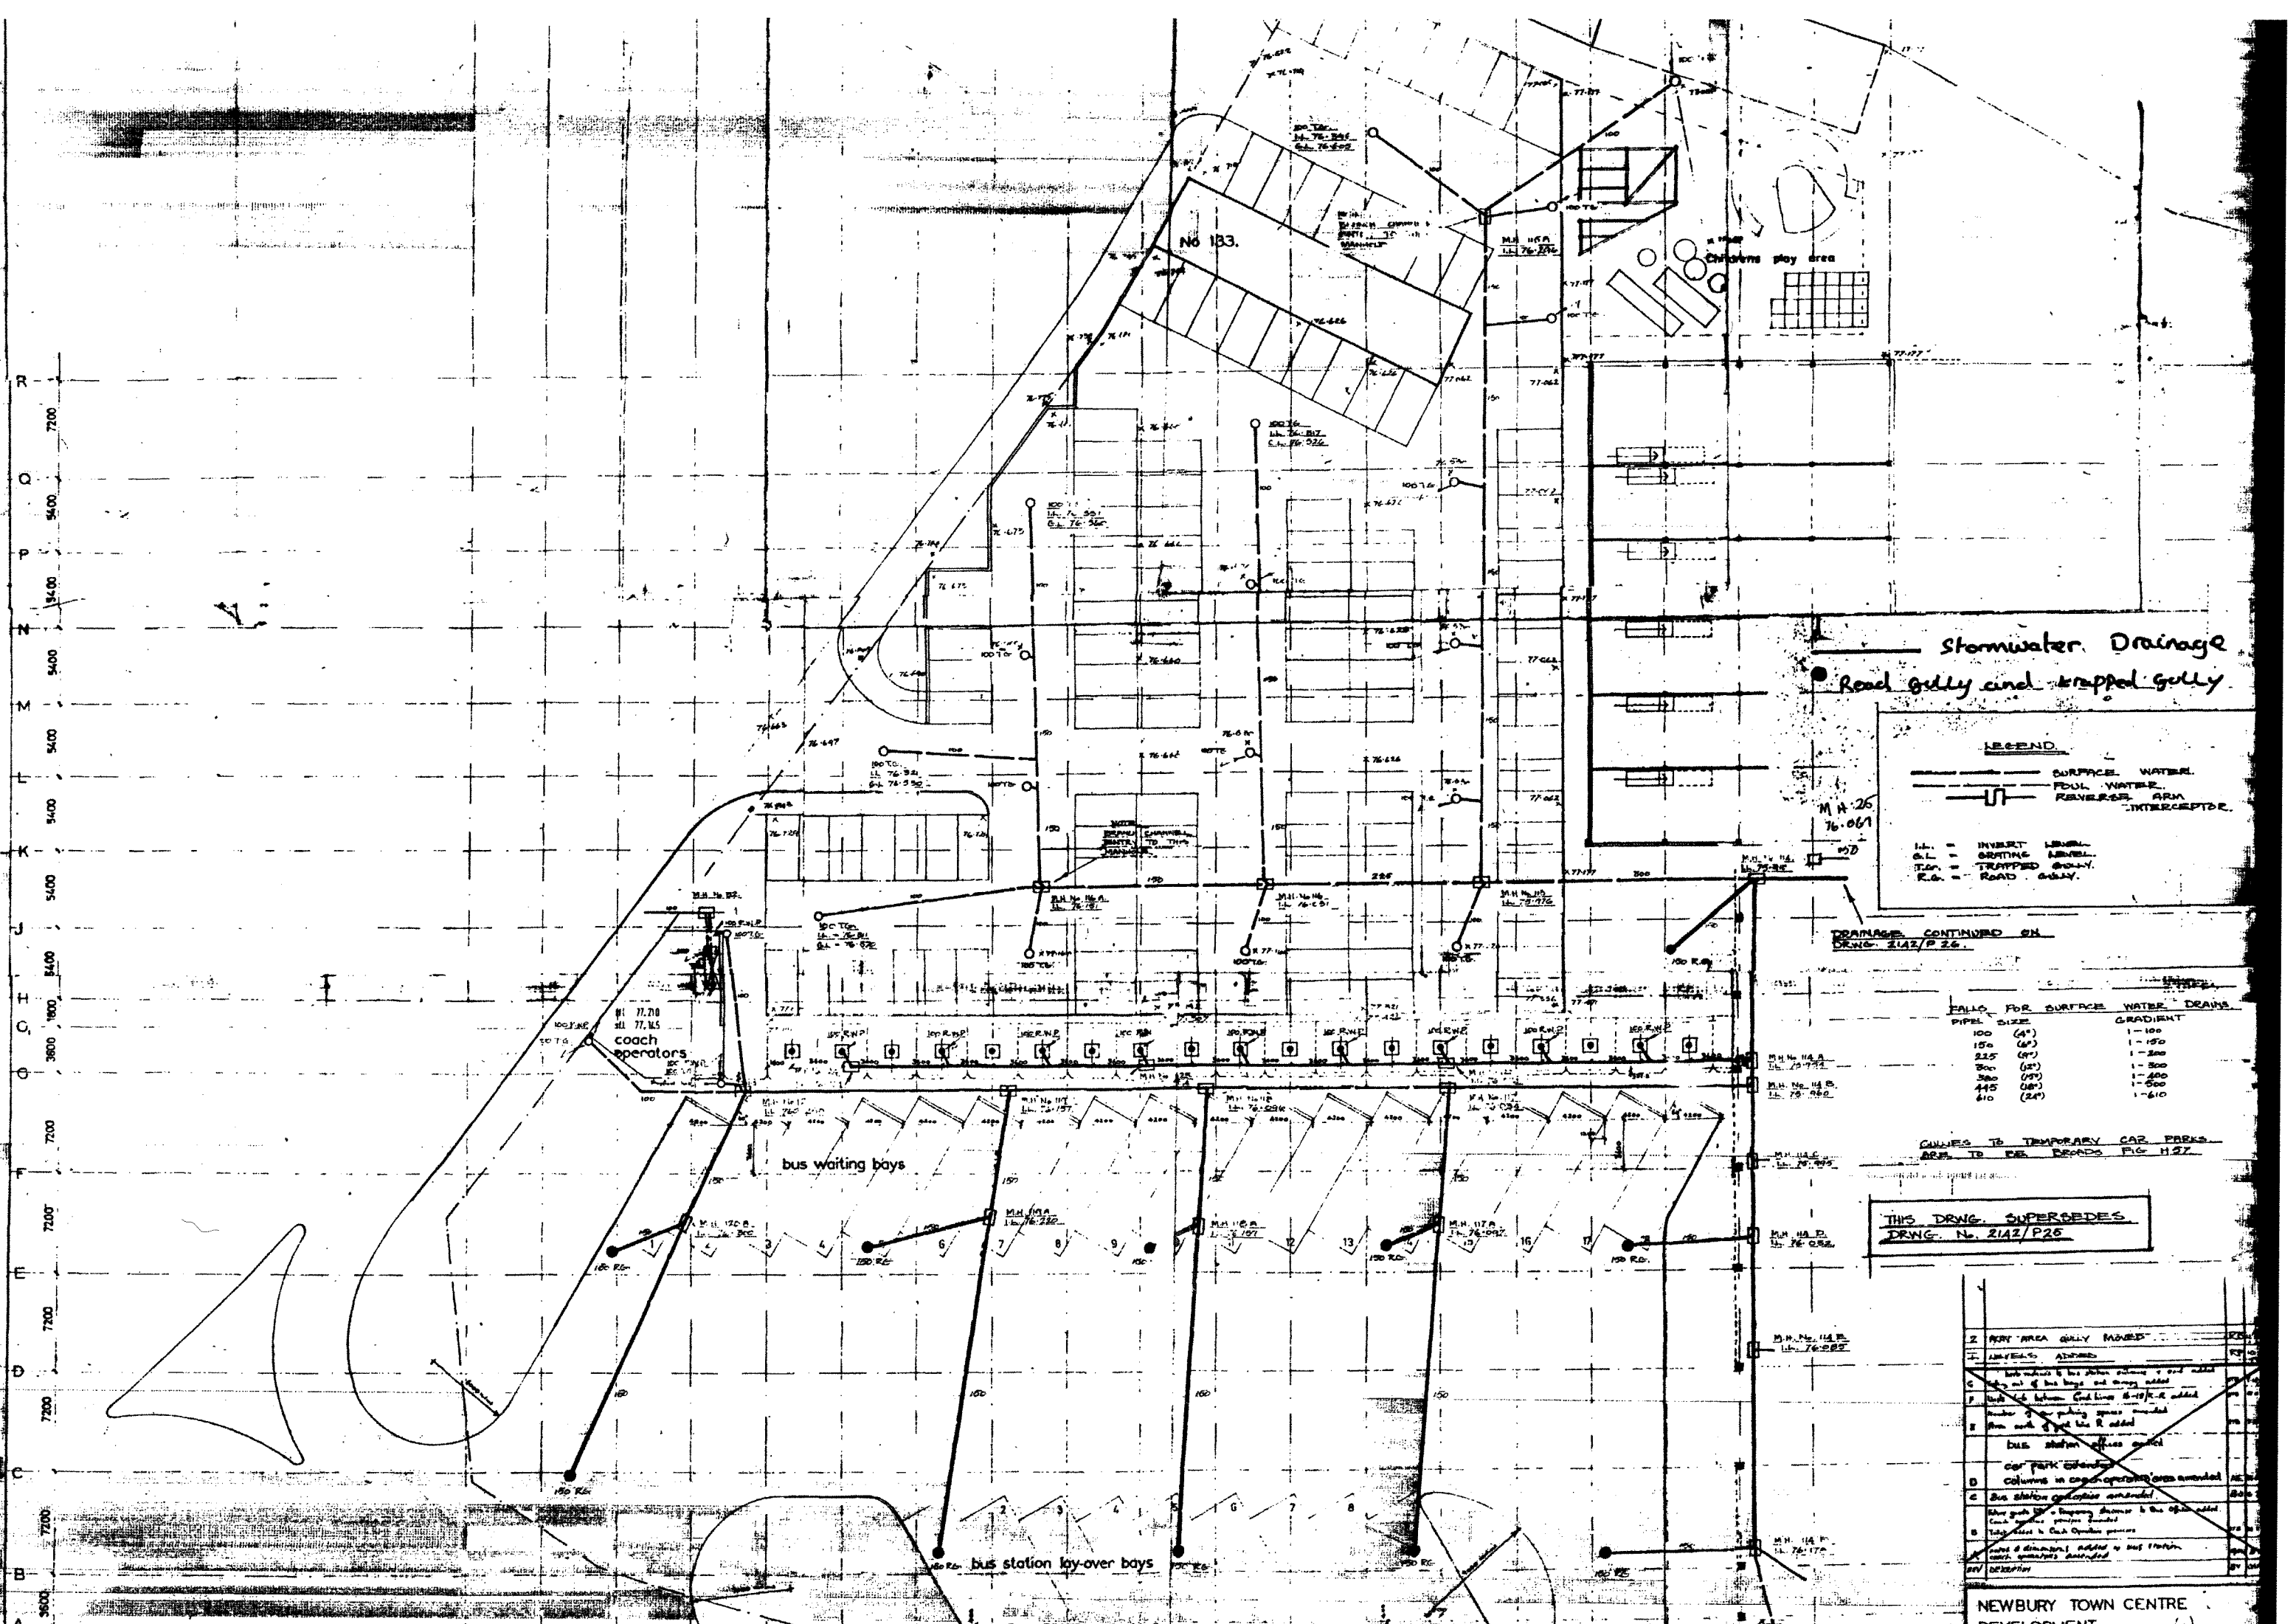

Stormwater Drainage
Road gully and trapped gully

LEGEND

— SURFACE WATER
— FOWL WATER
— REVERSE ARM
— INTERCEPTOR

IL = INVERT LEVEL
GL = GRATING LEVEL
TGP = TRAPPED GULLY
R.G. = ROAD GULLY

PIPE SIZE	GRADIENT
100 (4")	1-100
150 (6")	1-150
225 (9")	1-200
300 (12")	1-300
360 (15")	1-400
440 (18")	1-500
610 (24")	1-610


GULLIES TO TEMPORARY CAR PARKS
ARE TO BE RECORDED FIG. H.27

THIS DRWG. SUPERSEDES
DRWG. No. 2142/P25

REV.	DESCRIPTION	DATE
1	REVISION AREA GULLY ADDED	10/10
2	ADDED	10/10
3	ADDED	10/10
4	ADDED	10/10
5	ADDED	10/10
6	ADDED	10/10
7	ADDED	10/10
8	ADDED	10/10
9	ADDED	10/10
10	ADDED	10/10
11	ADDED	10/10
12	ADDED	10/10
13	ADDED	10/10
14	ADDED	10/10
15	ADDED	10/10
16	ADDED	10/10
17	ADDED	10/10
18	ADDED	10/10
19	ADDED	10/10

IMPORTANT
THIS DRAWING IS
RELEVANT FOR
SERVICES ONLY
FOR ALL OTHER INFORMATION
REFER TO THE LATEST
ARCHITECTURAL DRAWINGS



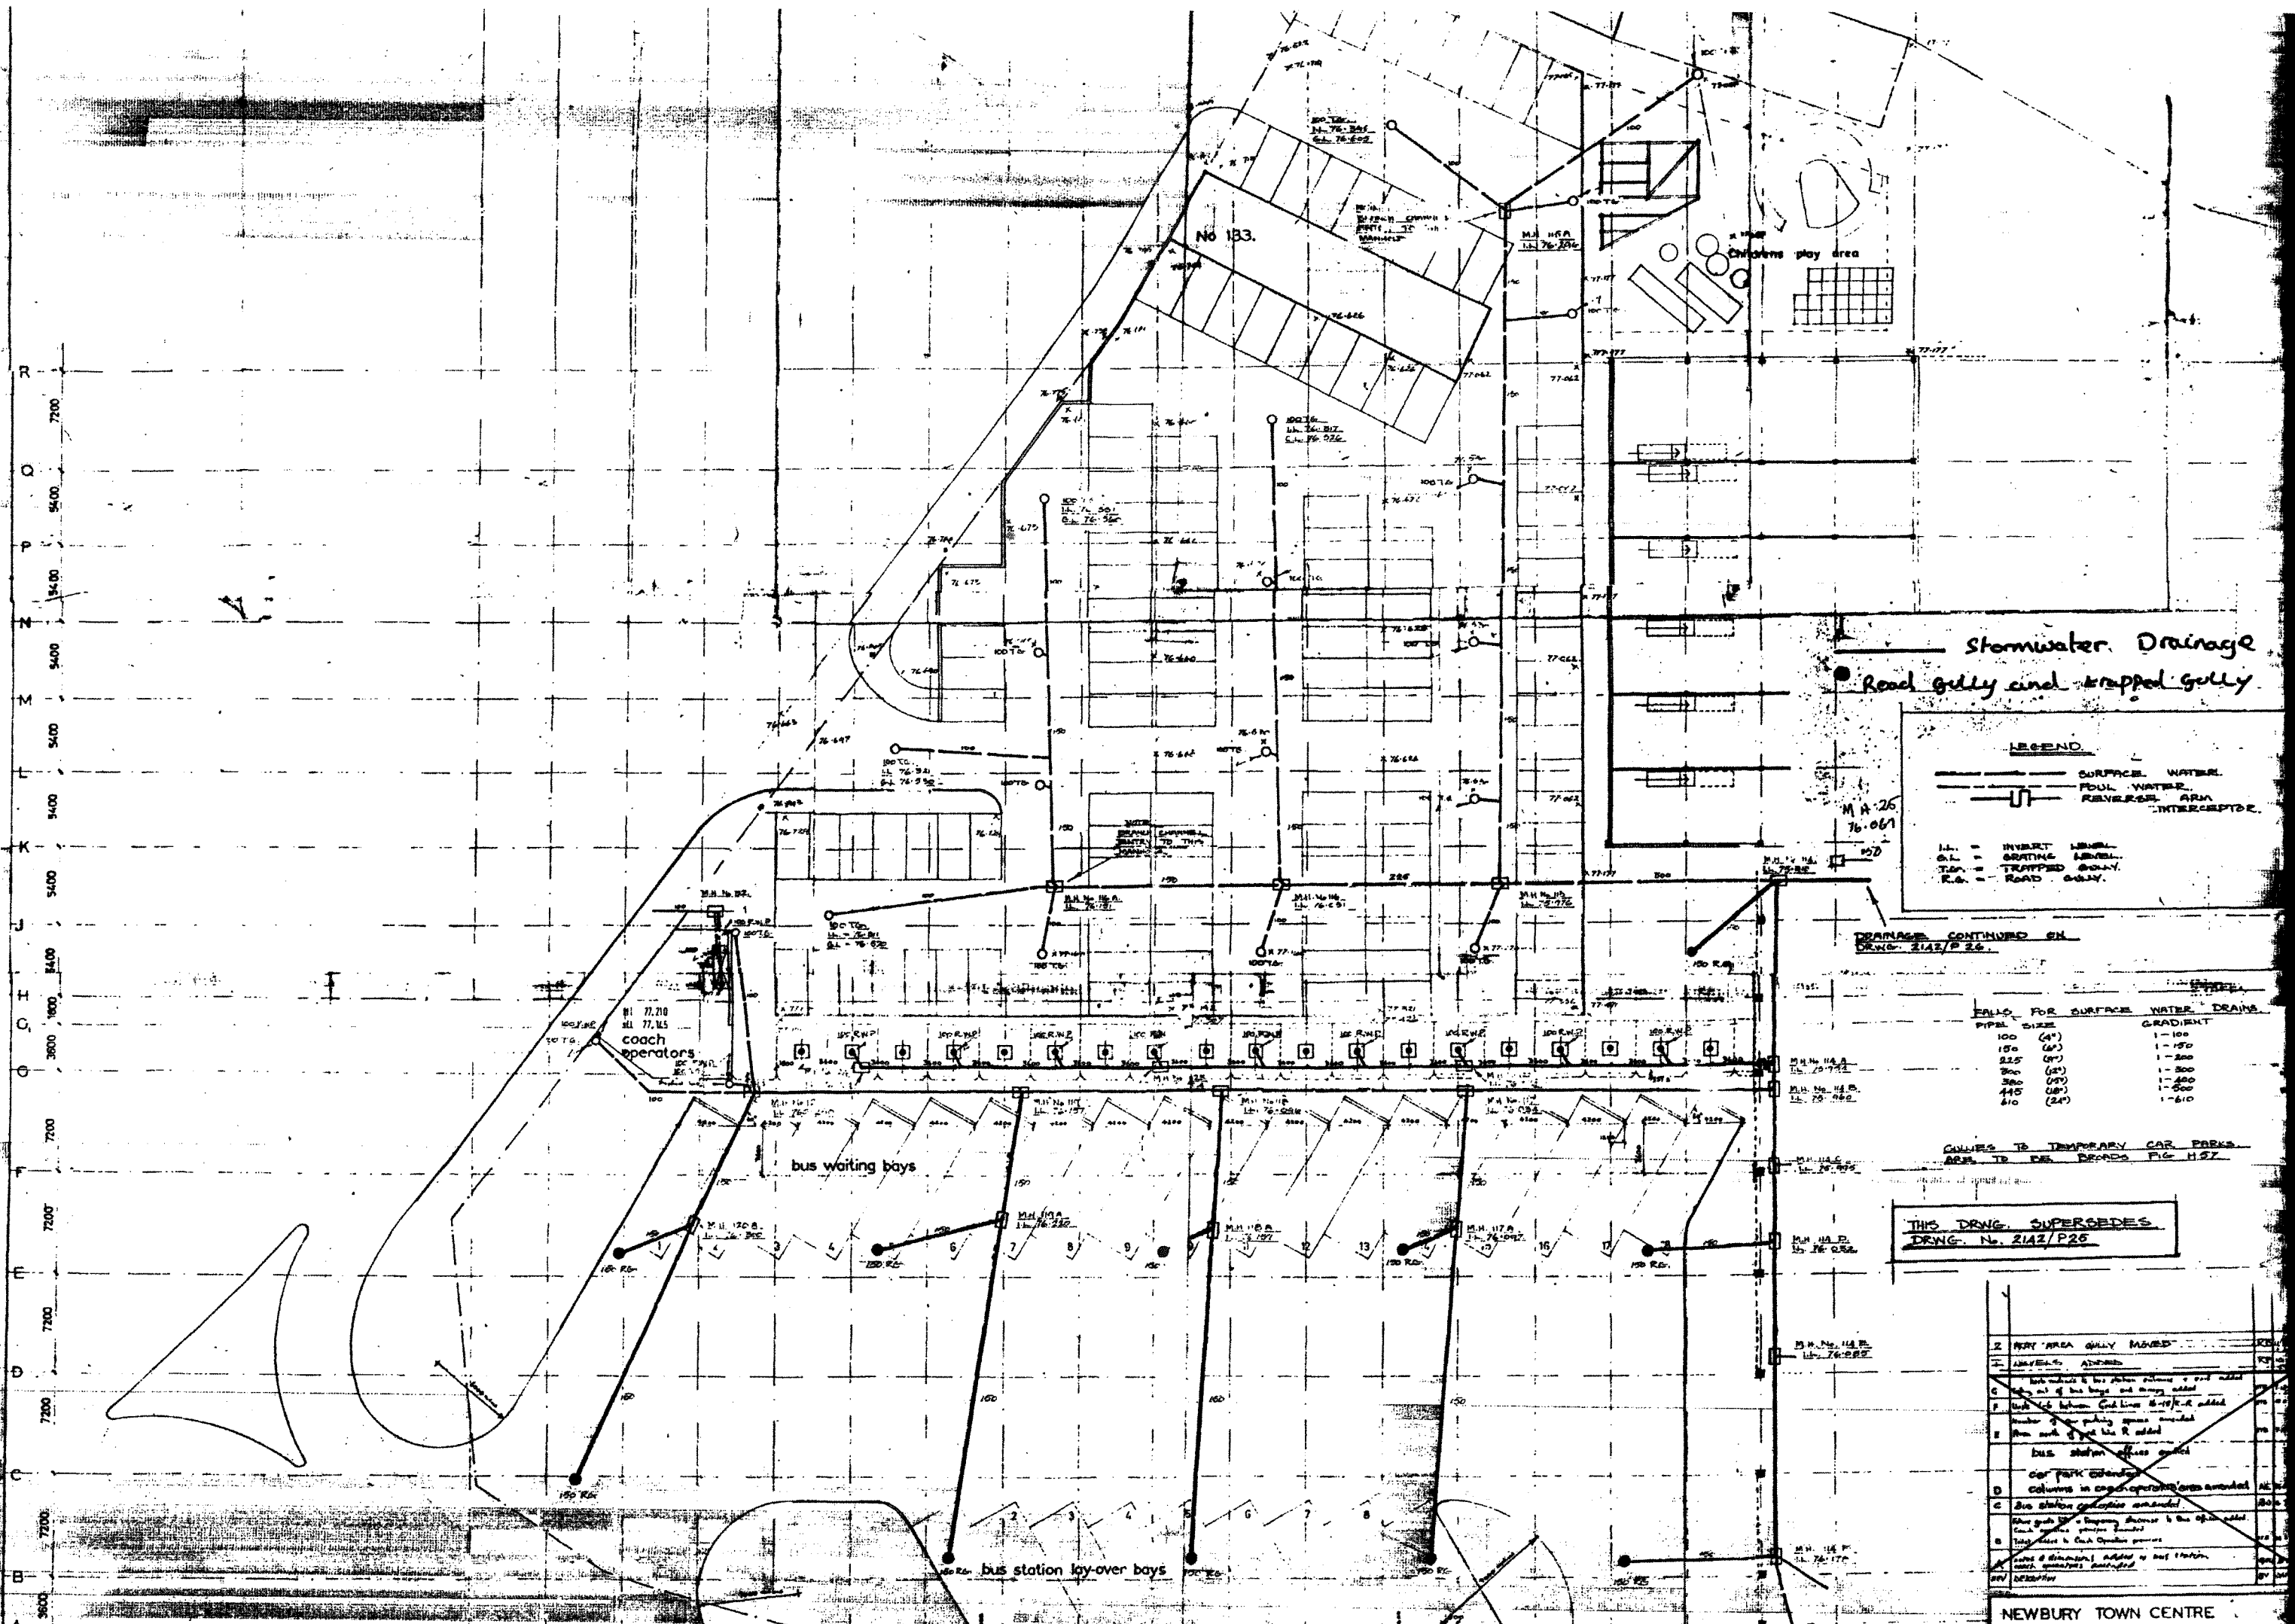

Stormwater Drainage
 Road gully and trapped gully

LEGEND

— SURFACE WATER
 - - - Foul Water
 [Symbol] REVERSE ARM
 [Symbol] INTERCEPTOR

M.H. = INVERT LEVEL
 G.L. = GRATING LEVEL
 T.G. = TRAPPED GULLY
 R.G. = ROAD GULLY

DRAINAGE CONTINUED ON
 DRWG. N. 2142/P. 26

TABLE FOR SURFACE WATER DRAINS


PIPE SIZE	GRADIENT
100 (4")	1-100
150 (6")	1-150
225 (9")	1-200
300 (12")	1-300
360 (15")	1-400
445 (18")	1-500
610 (24")	1-610

COLLIES TO TEMPORARY CAR PARKS
 AREA TO SEE DRAWING FIG. H.57


**THIS DRWG. SUPERSEDES
 DRWG. N. 2142/P. 26**

2	NEW AREA GULLY MOVED	OK
3	MANHOLE ADDED	OK
4	Manholes & bus station columns & road added	OK
5	Manhole & bus station columns & road added	OK
6	Manhole & bus station columns & road added	OK
7	Manhole & bus station columns & road added	OK
8	Manhole & bus station columns & road added	OK
9	Manhole & bus station columns & road added	OK
10	Manhole & bus station columns & road added	OK
11	Manhole & bus station columns & road added	OK
12	Manhole & bus station columns & road added	OK
13	Manhole & bus station columns & road added	OK
14	Manhole & bus station columns & road added	OK
15	Manhole & bus station columns & road added	OK
16	Manhole & bus station columns & road added	OK
17	Manhole & bus station columns & road added	OK

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RELEVANT FOR
SERVICES ONLY
FOR ALL OTHER INFORMATION
REFER TO THE LATEST
ARCHITECTURAL DRAWINGS

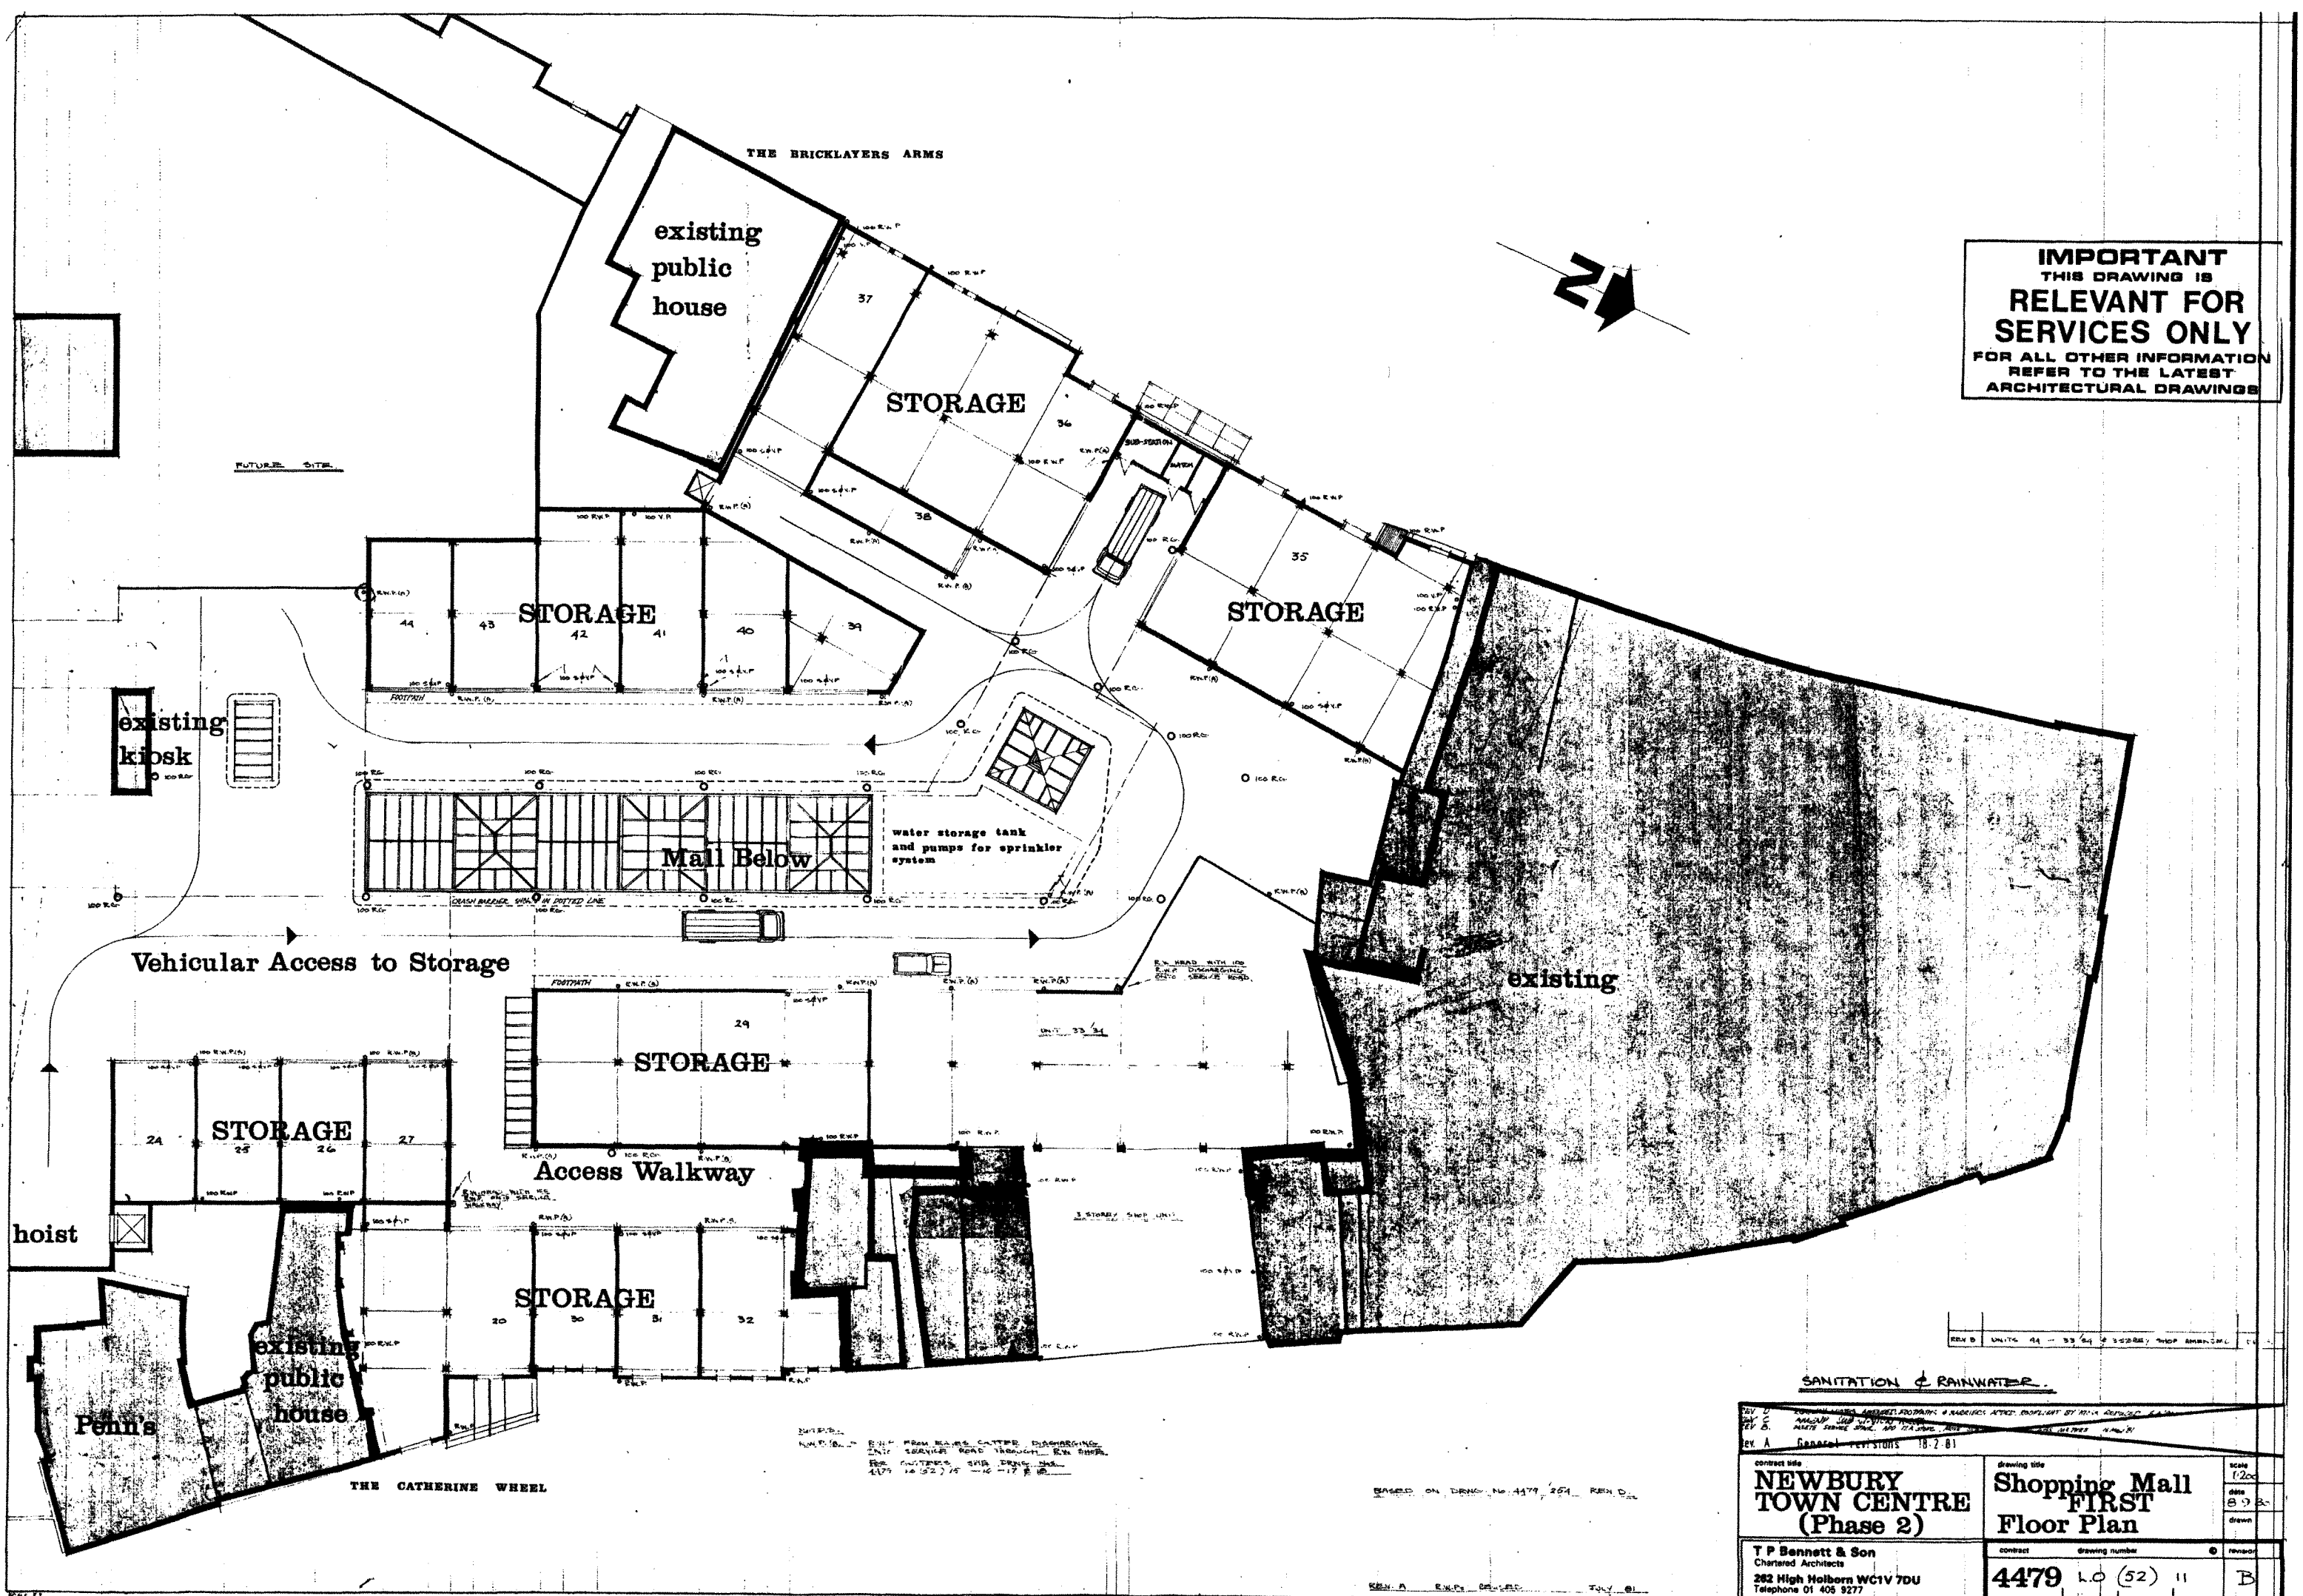

SANITATION & RAINWATER		Scale 1:200
REV D	REVISIONS	DATE
REV C	REVISIONS	DATE
REV B	REVISIONS	DATE
REV A	REVISIONS	DATE
NEWBURY TOWN CENTRE (Phase 2) Shopping Mall FIRST Floor Plan		Drawing title Drawing number 4479 L.O. (52) 11 B
T P Bennett & Son Chartered Architects 282 High Holborn WC1V 7DU Telephone 01 405 9277		Contract Drawing number Revision

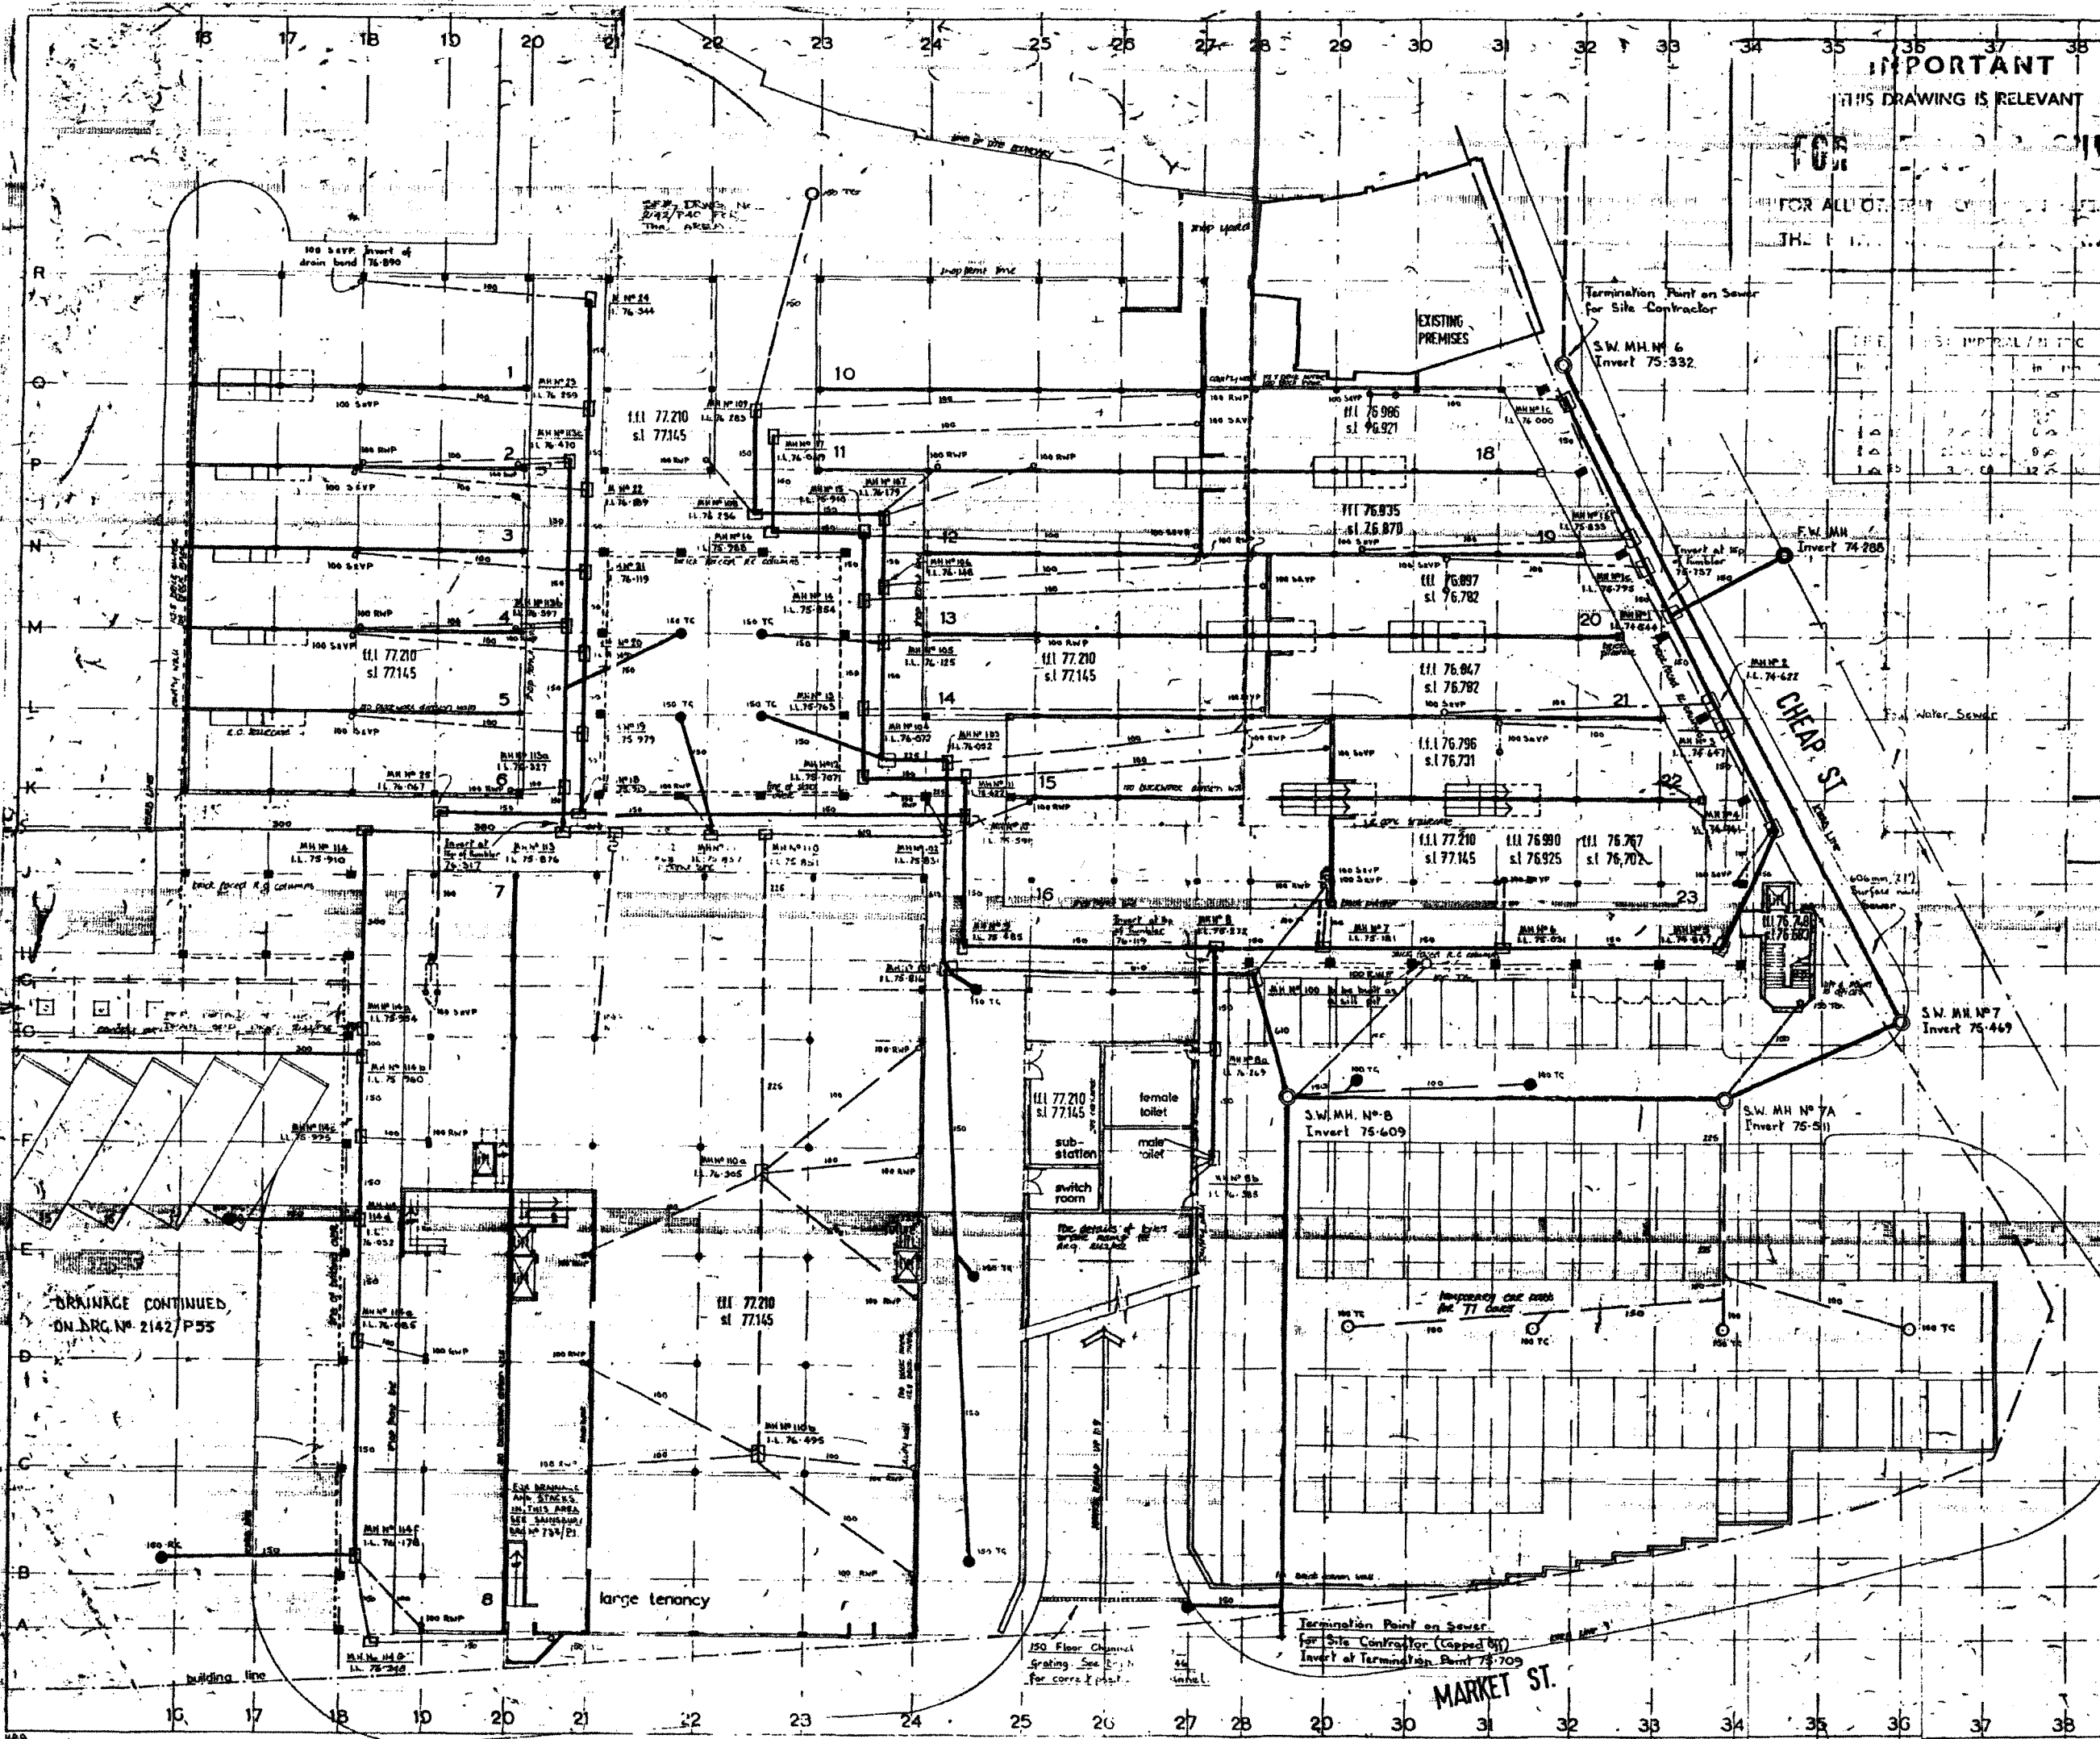

IMPORTANT
THIS DRAWING IS RELEVANT
FOR ALL OTHER WORK REFER TO
THE DRAWING

NOTES
For Legend See Drg No 2142/P25
This drawing supersedes
Drg No 2142/P23

Stormwater Drainage
Road gully and trapped gully
Foul Drainage

ALL DIMENSIONS IN MILLIMETRES
HEIGHTS IN METRES

DRAINAGE CONTINUED
ON DRC No 2142/P55

1	GRID ADDRESS TO M.H. 109	10/12 R.P.
2	M.H. 109 INVERT	10/12 R.P.
3	M.H. 109 INVERT	10/12 R.P.
4	GRID ADDRESS TO M.H. 109	10/12 R.P.
5	M.H. 109 INVERT	10/12 R.P.
6	M.H. 109 INVERT	10/12 R.P.
7	M.H. 109 INVERT	10/12 R.P.
8	M.H. 109 INVERT	10/12 R.P.
9	M.H. 109 INVERT	10/12 R.P.
10	M.H. 109 INVERT	10/12 R.P.
11	M.H. 109 INVERT	10/12 R.P.
12	M.H. 109 INVERT	10/12 R.P.
13	M.H. 109 INVERT	10/12 R.P.
14	M.H. 109 INVERT	10/12 R.P.
15	M.H. 109 INVERT	10/12 R.P.
16	M.H. 109 INVERT	10/12 R.P.
17	M.H. 109 INVERT	10/12 R.P.
18	M.H. 109 INVERT	10/12 R.P.
19	M.H. 109 INVERT	10/12 R.P.
20	M.H. 109 INVERT	10/12 R.P.
21	M.H. 109 INVERT	10/12 R.P.
22	M.H. 109 INVERT	10/12 R.P.
23	M.H. 109 INVERT	10/12 R.P.
24	M.H. 109 INVERT	10/12 R.P.
25	M.H. 109 INVERT	10/12 R.P.
26	M.H. 109 INVERT	10/12 R.P.
27	M.H. 109 INVERT	10/12 R.P.
28	M.H. 109 INVERT	10/12 R.P.
29	M.H. 109 INVERT	10/12 R.P.
30	M.H. 109 INVERT	10/12 R.P.
31	M.H. 109 INVERT	10/12 R.P.
32	M.H. 109 INVERT	10/12 R.P.
33	M.H. 109 INVERT	10/12 R.P.
34	M.H. 109 INVERT	10/12 R.P.
35	M.H. 109 INVERT	10/12 R.P.
36	M.H. 109 INVERT	10/12 R.P.
37	M.H. 109 INVERT	10/12 R.P.
38	M.H. 109 INVERT	10/12 R.P.

NEWBURY TOWN CENTRE DEVELOPMENT (i)
ground floor DRAINAGE
Grid Lines 16-38

T. P. BARNETT & SONS
Chartered Accountants
40 Boundary Square W.C.1
Russell Place NOTTINGHAM


ARTHUR LING ASSOCIATES
Consultant Architects
40 Boundary Square W.C.1
Russell Place NOTTINGHAM


Scale 1:200
Date 12/12/71
Drawn
Checked

Dwg. No. 2142/P26
Revision D

Appendix C

Historic Photos

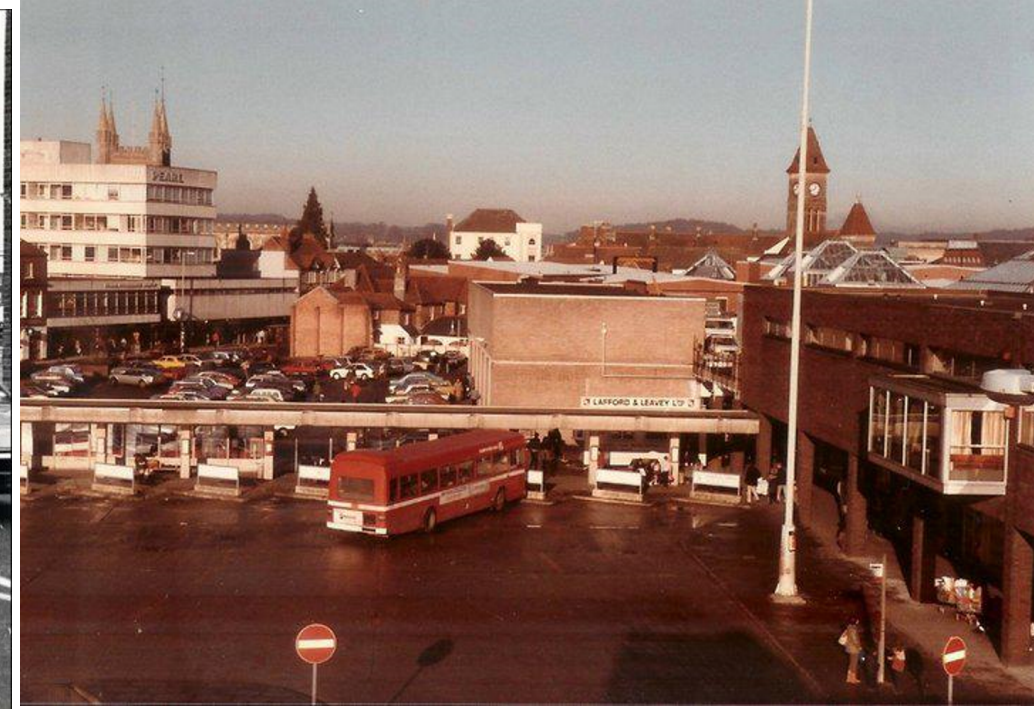

	Title: <i>Pre-Phase 3 Construction Photos</i>			
	Project: <i>Kennet Centre</i>			
	Job No: <i>4508</i>	By: <i>ce</i>	Chk: <i>ce</i>	App: <i>ce</i>
	Date: <i>04/10/2019</i>	Status: <i>FOR INFORMATION</i>		
	Sketch No:			Rev:



Robert Bird & Partners Limited
Registered in the UK. Company No. 4472743

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F: +44 (0) 20 7928 4477